# 1234 Vernon Ave Proposed Existing

Lot Size xxx m2 (xxx ft2)

Zone RS-6

### **Lot Coverage**

Principal Residence xxx m2 (xxx ft2)
Accessory Building(s) xxx m2 (xxx ft2)/ x%
Total Lot Coverage xxx m2 (xxx ft2)/ x%

#### **Setbacks**

Front Lot Line Setback	x.xx m (x'x")
Rear Lot Line Setback	x.xx m (x'x")
Combined Front and Rear Setback	x.xx m (x'x")
Interior Side Lot Line Setback (West)	x.xx m (x'x")
Interior Side Lot Line Setback (East)	x.xx m (x'x")
Combined Sideyard Setback	x.xx m (x'x")

### Height

Average Grade	x.xx m
Highest Sloped Roof Height	x.xx m (x'x")
Highest Flat Roof Height	x.xx m (x'x")

## **Single Face Height**

Average Grade at Lowest Outermost Wall x.xx m Single Face Height x.xx m (x'x")

#### Floor Area

Upper Floor Area	x.xx m2 (x.xx ft2)
Lower Floor Area	x.xx m2 (x.xx ft2)
Garage	x.xx m2 (x.xx ft2)
Garage Exemption	x.xx m2 (x.xx ft2)
Total Gross Floor Area	x.xx m2 (x.xx ft2)
Secondary Suite Floor Area (incl. above)	x.xx m2 (x.xx ft2)

\*Note: Please include all floor areas, including basement areas, if required.

\*Note: Please submit all the required information for the existing house portion if you are doing a renovation or addition.

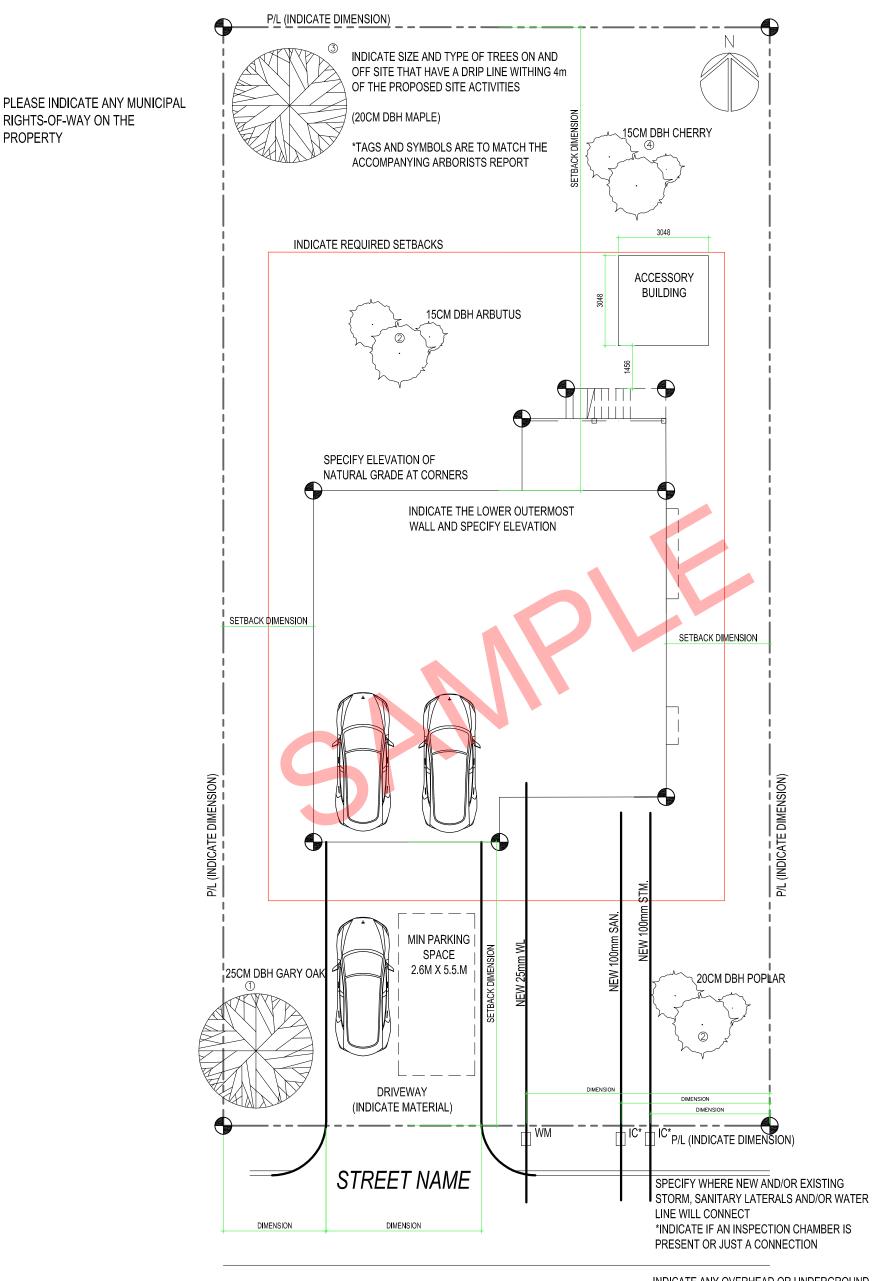
Please refer to the Zoning Bylaw or Zoning staff for any clarifications or definitions.

SAMPLE SINGLE FAMILY DWELLING 770 VERNON AVE VICTORIA BC



CONSTRUCTION DRAWINGS
VICTORIA BC 250 475 XXXX
inspections@saanich.ca
www.saanich.ca

DATE:	MARCH2020	
DRAWN:	m. Wiesel	Li
SCALE :	N/A	17
PROJECT :	SFD	



1' 5' 10' 20'

INDICATE ANY OVERHEAD OR UNDERGROUND UTILITIES (TELUS, HYDRO, FORTIS ETC.)

NOTE:

A SURVEY MAY BE REQUIRED TO CONFIRM LOCATION BEFORE THE FRAMING INSPECTION

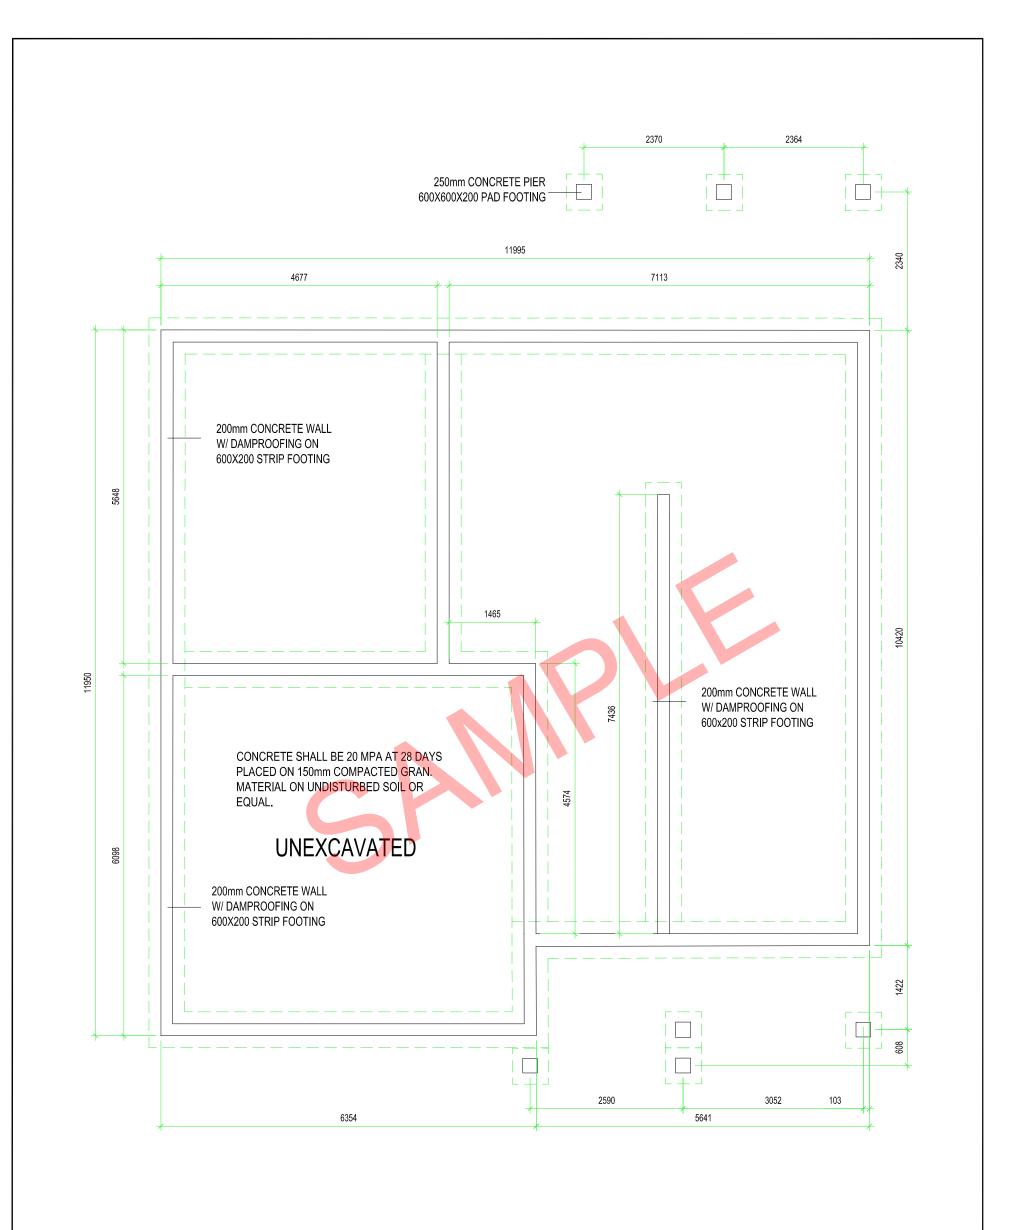
SITE PLAN

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DATE:	MARCH2020	
DRAWN:	m. Wiesel	
SCALE :	3/32" = 1'	
PROJECT :	SFD	



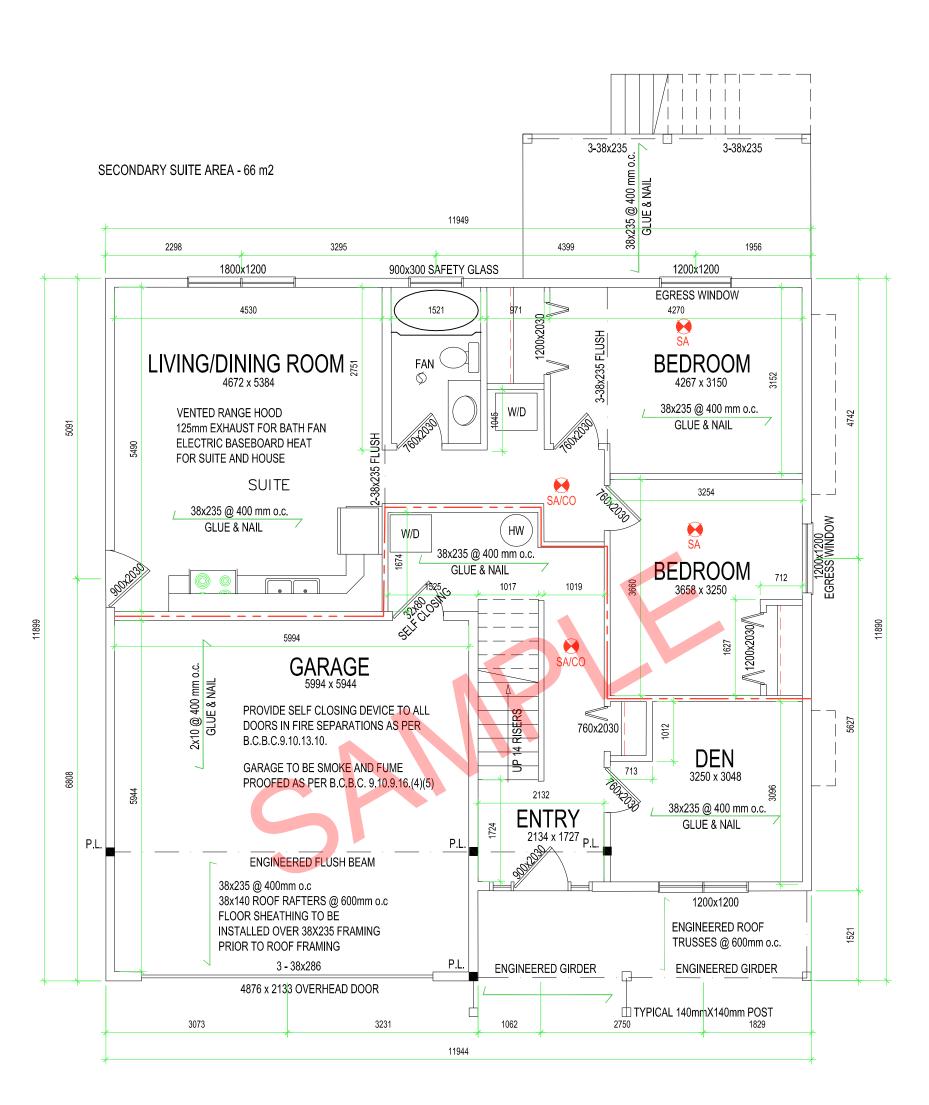
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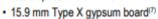
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DRAWN:	m. Wiesel	
SCALE :	3/16" = 1'	ı
PROJECT :	SFD	l

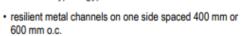


#### FIRE SEPARATION WALL AND FLOOR DETAIL

W4 with • studs

studs spaced 400 mm o.c.





- 2 layers of gypsum board on resilient metal channel side
- 1 layer of gypsum board on other side

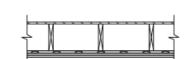
F9c(16)

F9 with

absorptive material in cavity

resilient metal channels spaced 400 mm o.c.

15.9 mm Type X gypsum board



NOTE:

STRUCTURAL DESIGN MAY REQUIRE THE SERVICES OF A PROFESSIONAL ENGINEER

LOWER FLOOR

102 m2 + 39 m2 GARAGE

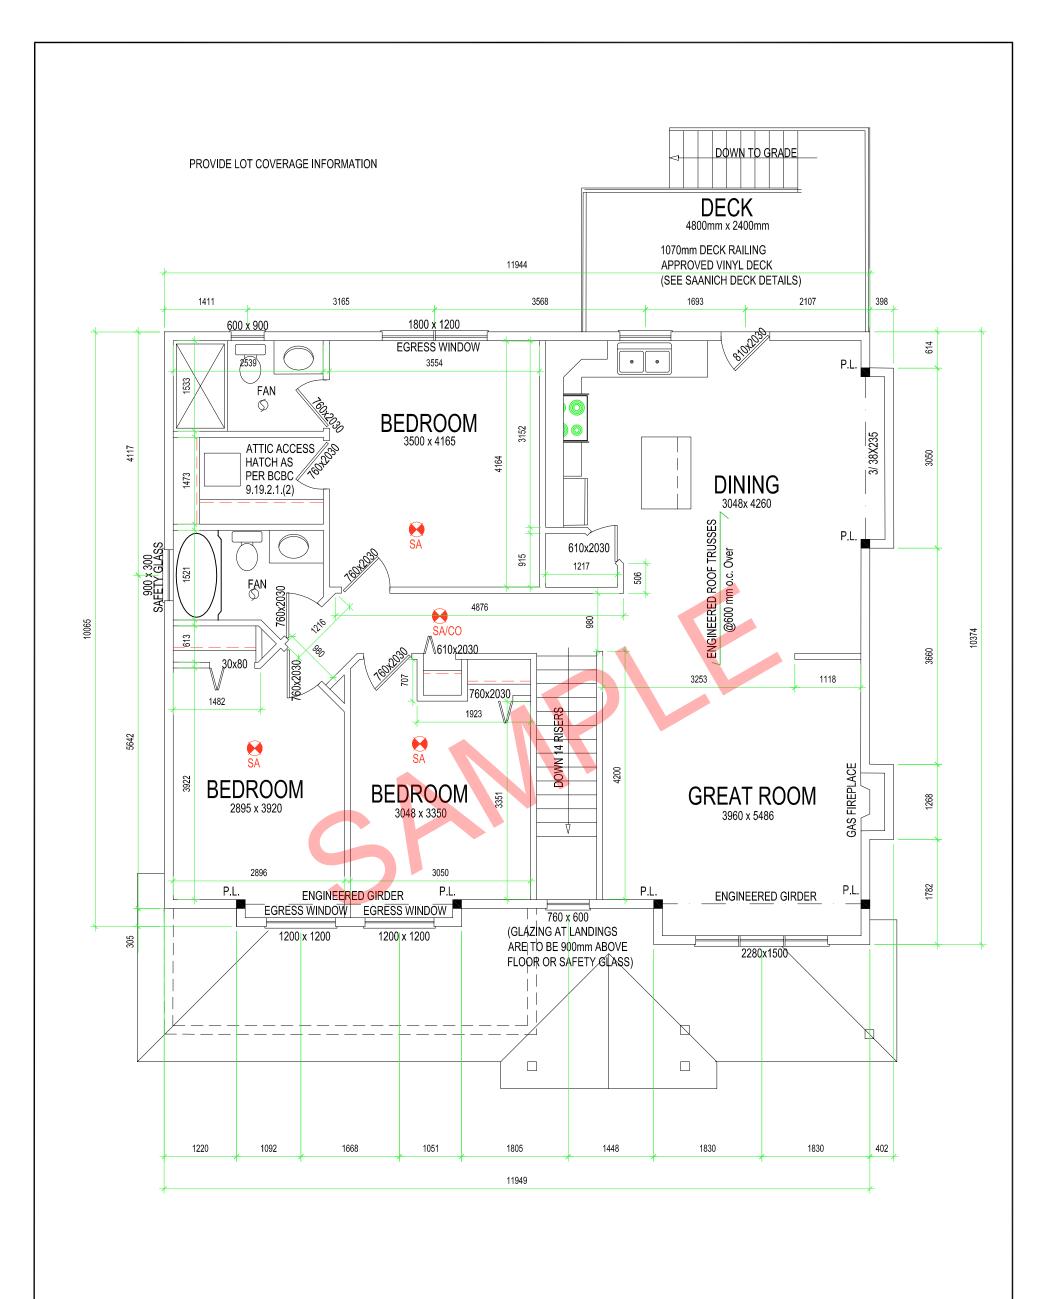
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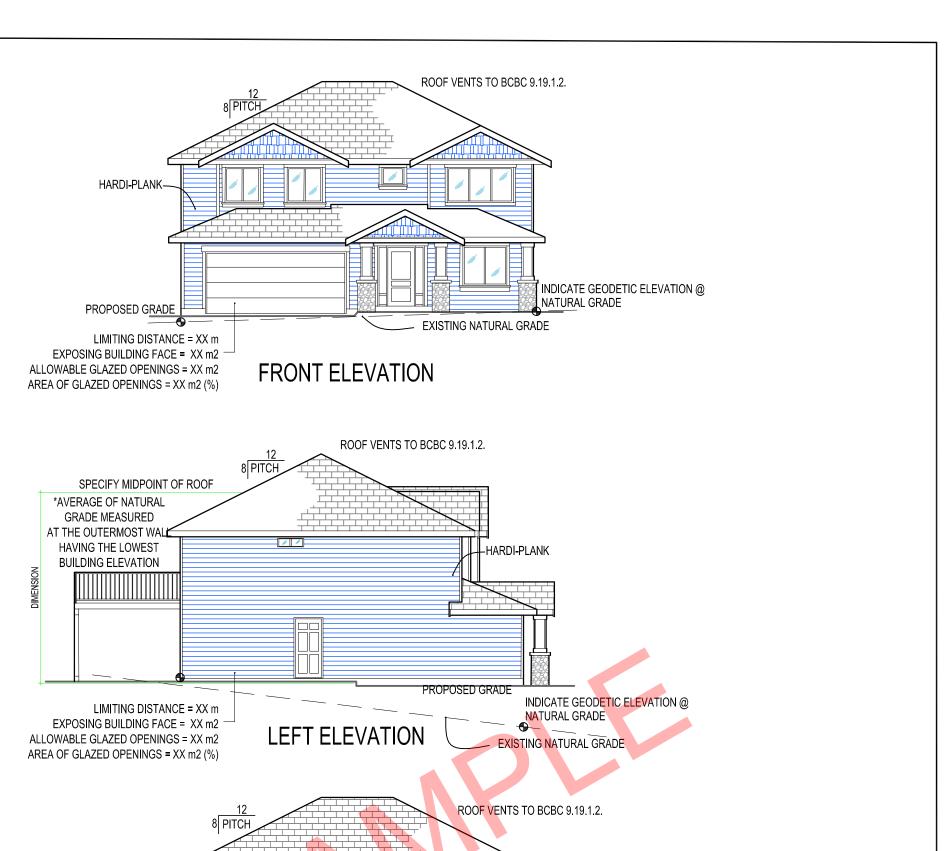
MAIN FLOOR

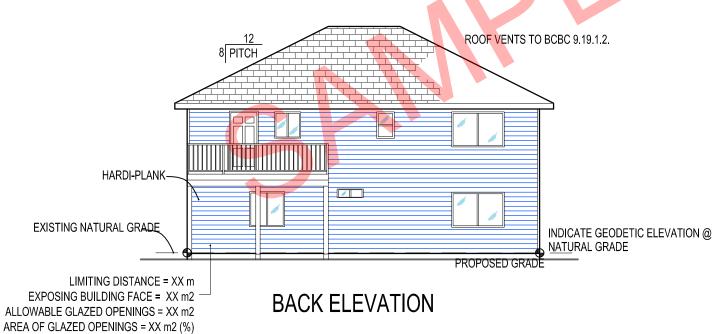
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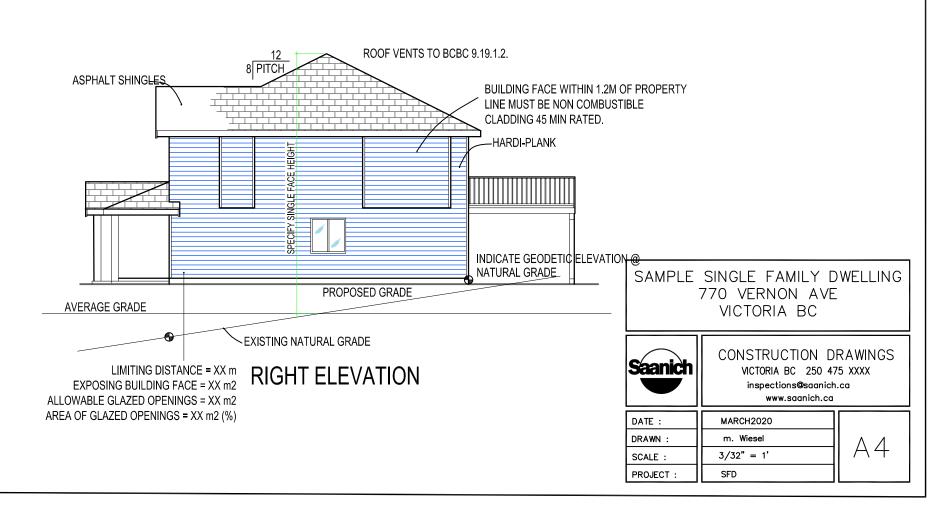


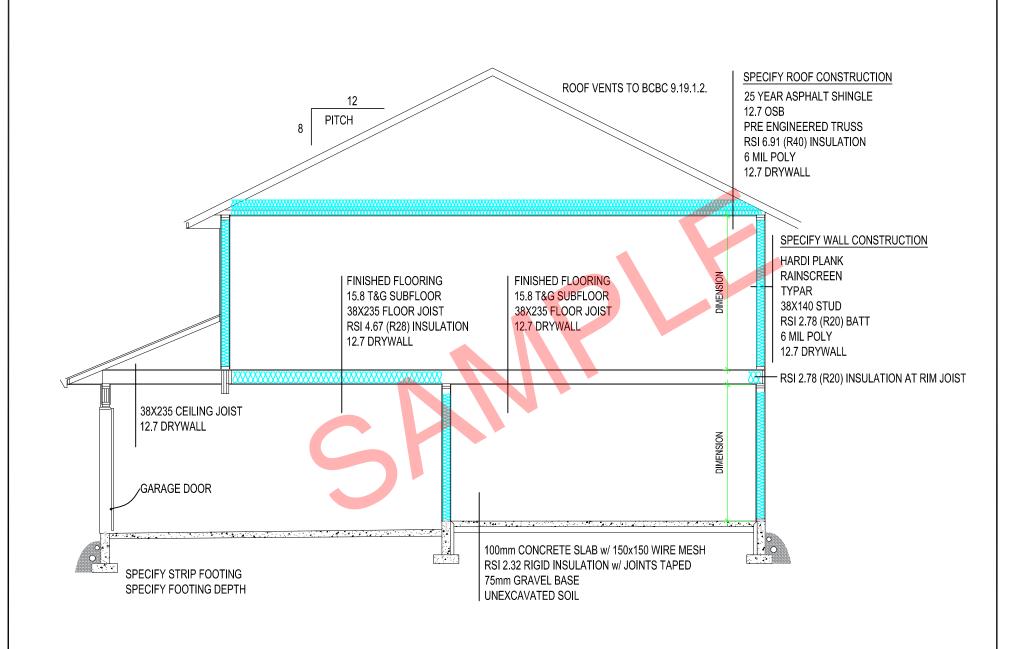
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