DESIGN RATIONALE

DESIGN RATIONALE
OVERALL DESIGN THEMATICS
The overall landscape design is based on three core themstics: social interaction, placemaking and ecology. We want to create a series of welcoming and impiring publicly accessible spaces that bring people together. We want to create a unique peletts of materials that it is replained by both building form and regional character as way that resentes strongly with residents and violtors silke. And we went to design with sustainable principles in mid - rainwater collection, absorptive landscapes, and using local materials that are naturally durable and abundant on the Sasnich Peninsula.

GLANFORD FRONTAGE

GLANPORD FRONTAGE
The upper terrace of the site, directly adjacent to Glanford Are, functions as a long publicly accessible space that maintains the "green buffer" between Glanford and the proposed development. It is essentially divided into 3 livels: the uppermost community green space, a great mound with automating stees, pathways and essenting opportunities with south-facing views: a welcoming and inmiting "gatewisy" plaze that provides a window into the heart of the site with fasture paring and sessing, sippage and access to the resident'all cannellations and a feature terraced aim garden to mitigate stormwater runoff while a backdrop to the sito's signature comer.

PUBLIC RASEO

This is the main pedestrean comider into the sits, with a grand public staircase descending estitural and buffered with Garry Oak Ecosystem-inspired landscape beds and core-ten steel wells, eventually giving very to a restal access plaze at its base. Moving further along this middle terrace, mounded rain gardens, cut into the paving partern, with seating and shade trees, offers a more relating gathering space adjacent to the residential folibly. Access to the row of commercial/retail units, along with the pub/restaurant, lines the south edge.

LOWER TERRACE

The main access point into the site at its lower end, this space is anchored by a future publirestaurant with an adjacent outdoor patio zone to take advantage of the southern sun exposure. This velocinning plass is designed for the pedestain scale, in highlighted with a rain garden and seating for passive use. Along the perimeter against the townhome units are wide terraced fanckaspe beds ingriped by the fornic Garry Oak Meedow ecosystem common in the area, with boulder and core-ten well accents.

FITNESS LOOP/MUILTI-LISE TRAIL.
This private residential amenity will provide additional circulation for residents, linking the fower, middle and upper tenaces with a multi-use pathway. Along the way, users will encounter existing large mature trees, new nutrier plentings that mimic the Garry Oak Meadow ecosystem, and pleasable fitness stations to take advantage of the site's large "green" buffers along its north edest edges.

KEY ITEMS

A GLANFORD FRONTAGE

NATURALIZED "GARRY OAK" LANDSCAPE, NATIVE SHRUBS PERENNIALS, TREES + BOULDER OUTCROPS
 COMMUNITY GREEN SPACE OPEN GRASS, BENCHES AND GRAVEL PATHS

AVE.

- 3 GATEWAY PLAZA: FEATURE PAYING, LOW LANDSCAPE WALLS AND SIGNAGE
- RAIN GARDEN FOR STORMWATER RETENTION, TERRACED ROCK WALLS
- ACCESS TO RESIDENTIAL CATWALK

B PUBLIC PASEO

- RETAIL ACCESS
- 8 PLANTING BERMS ON SLAB. SHADE TREES, PERENNIALS + PUBLIC SEATING
- 9 LOBBY ENTRY AND ACCESS TO PRIVATE FITNESS LOOP
- PASED ACCESS TO RESTAURANT

THE LOWER TERRACE

- RAIN GARDEN/STORMWATER RETENTION FEATURE: LOW WALLS + SEATING
- RESTAURANT PATIO ZONE (LICENSED); COVERED
- NATURALIZED "GARRY OAK" MEADOW LANDSCAPE BERMS INTEGRATED WITH PAYING + SEATING; BUFFER FOR PRIVATE PATIOS

PRIVATE FITNESS AMENITY / NATURE TRAIL

- 14 ACCESS GATE
- MULTI-USE TRAIL ACCESS
- 6 EXISTING TREE GROVE TO REMAIN (OFFSITE): PROTECTED
- PROPOSED GARRY OAK MEADOW ECOSYSTEM ADJACENT TO TRAILS





ECEIVE FEB 0 9 2022

> PLANNING DEPT. DISTRICT OF SAANICH

Architecture Inc

PLOT INFO.

NOTES

ISSUED / REVISIONS NO DESCRIPTION L RE-ISSUED FOR DP 2022-02-04 K RE-ISSUED FOR DP 2021-08-06 I ISSUED FOR REVIEW H ISSUED FOR CLIENT REVIEW 2021-05-21 G REZONING / DEVELOPMENT
PERMIT RE-SUBMISSION 2020-07-03 F REZONING / DEVELOPMENT PERMIT RE-SUBMISSION E ISSUED FOR REZONING / DEVELOPMENT PERMIT

GLANFORD AVENUE, SAANICH - BC

GROUND LEVEL LANDSCAPE CONCEPT PLAN

DATE, AUGUST 6TH 2021 DRAWN BY, CB CHECKED BY ME SCALE 1,200 JOB NUMBER: 19166

L1.0

GROUND LEVEL LANDSCAPE LEGEND DESCRIPTION PAVING TYPE 2 - SIDEWALK AS PER DISTRICT STANDARDS SEE CIVIL SEATING TYPE 1
CONCRETE BENCHES WITH WOOD TOP SEATING TYPE 2 FREE STANDING PARK BENCHES CIP CONCRETE STAIRS W/ HANDRAILS ARCHITECTURAL FINISH PROPOSED PLANTING - ONSITE/OFFSITE REFER TO PLANTING PLAN PROPOSED PLANTING - STREETSCAPE REFER TO PLANTING PLAN EXISTING PROPERTY LINE WALL TYPE 1 ACCENT STONE FACE WALL

WALL TYPE 2 ACCENT STEEL WALL - MAX 4" HT

WALL TYPE 4
ACCENT STEEL WALL - WITH GATE

WALL TYPE 3
BASALT BOULDER STACK WALL, HT VARIES (AVG. 2-4)

GENERAL LAYOUT + MATERIALS NOTES:

JALL DIMENSIONS ARE METRIC UNLESS OTHERWISE NOTED VERIFY ALL
DIMENSIONS WITH FIELD CONDITIONS. REPORT ANY DISCREPANCIES TO
LANDSCAFE ARCHITECT FOR REVIEW AND RESPONSE.

ALL UTILITIES TO BE STAKED QUIT BY CONTRACTOR AND PROTECTED FOR
DURATION OF CONSTRUCTION PERIOD.

UNLESS OTHERWISE NOTED, PROVIDE A MINIMUM 2% SLOPE ON ALL HARD AND SOFT LANDSCAPE AREAS TO ENSURE POSITIVE DRAINAGE AWAY FROM BUILDINGS OR TO DRAINAGE STRUCTURES MAXIMUM 3.1 SLOPE IN SOFT LANDSCAPE AREAS.

THE LAYOUT OF ALL HARDSCAPE (TEMS, SITE FURMSHINGS, BOULDERS, LANDSCAPE LIGHTING, PLANTING BEDS AND OTHER MATERIALS IS TO BE STAKED OUT BY THE CONTRACTOR AND APPROVED BY THE LANDSCAPE ARCHITECT PROR TO INSTALLATION

ALL SUBSTITUTIONS OF SPECIFIED MATERIALS TO BE APPROVED BY LANDSCAPE ARCHITECT.

TOTAL LANDSCAPE PERVIOUS AREA (ON SITE): 3,836 SQ M

TOTAL LANDSCAPE IMPERVIOUS AREA (ON SITE): 1,718 SQ M

loci SCAPE ARCHITECTURE + URBAN DESIGN

Architecture Inc

PLOT INFO.

8 * GLANFORD AVE. 1 0 8 8 8 **(B)** (1) **ENTERPRISE CRESCENT** GROUND LEVEL MATERILISPUS ECEIVE FEB 0 9 2022 PLANNING DEPT. DISTRICT OF SAANICH

NOTES

ISSUED / REVISIONS NO DESCRIPTION L RE-ISSUED FOR DP K RE-ISSUED FOR DP

J ISSUED FOR COORDINATION 2021-07-20 I ISSUED FOR REVIEW 2021-06-02 H ISSUED FOR CLIENT REVIEW 2021-05-21 G REZONING / DEVELOPMENT PERMIT RE-SUBMISSION

2022-02-04


2021-08-06

F REZONING / DEVELOPMENT PERMIT RE-SUBMISSION E ISSUED FOR REZONING / DEVELOPMENT PERMIT

GLANFORD AVENUE, SAANICH - BC

GROUND LEVEL LANDSCAPE MATERIALS PLAN

DATE: AUGUST 6TH 202 DRAWN BY: CB CHECKED BY: ME SCALE 1,200 JOB NUMBER: 19166

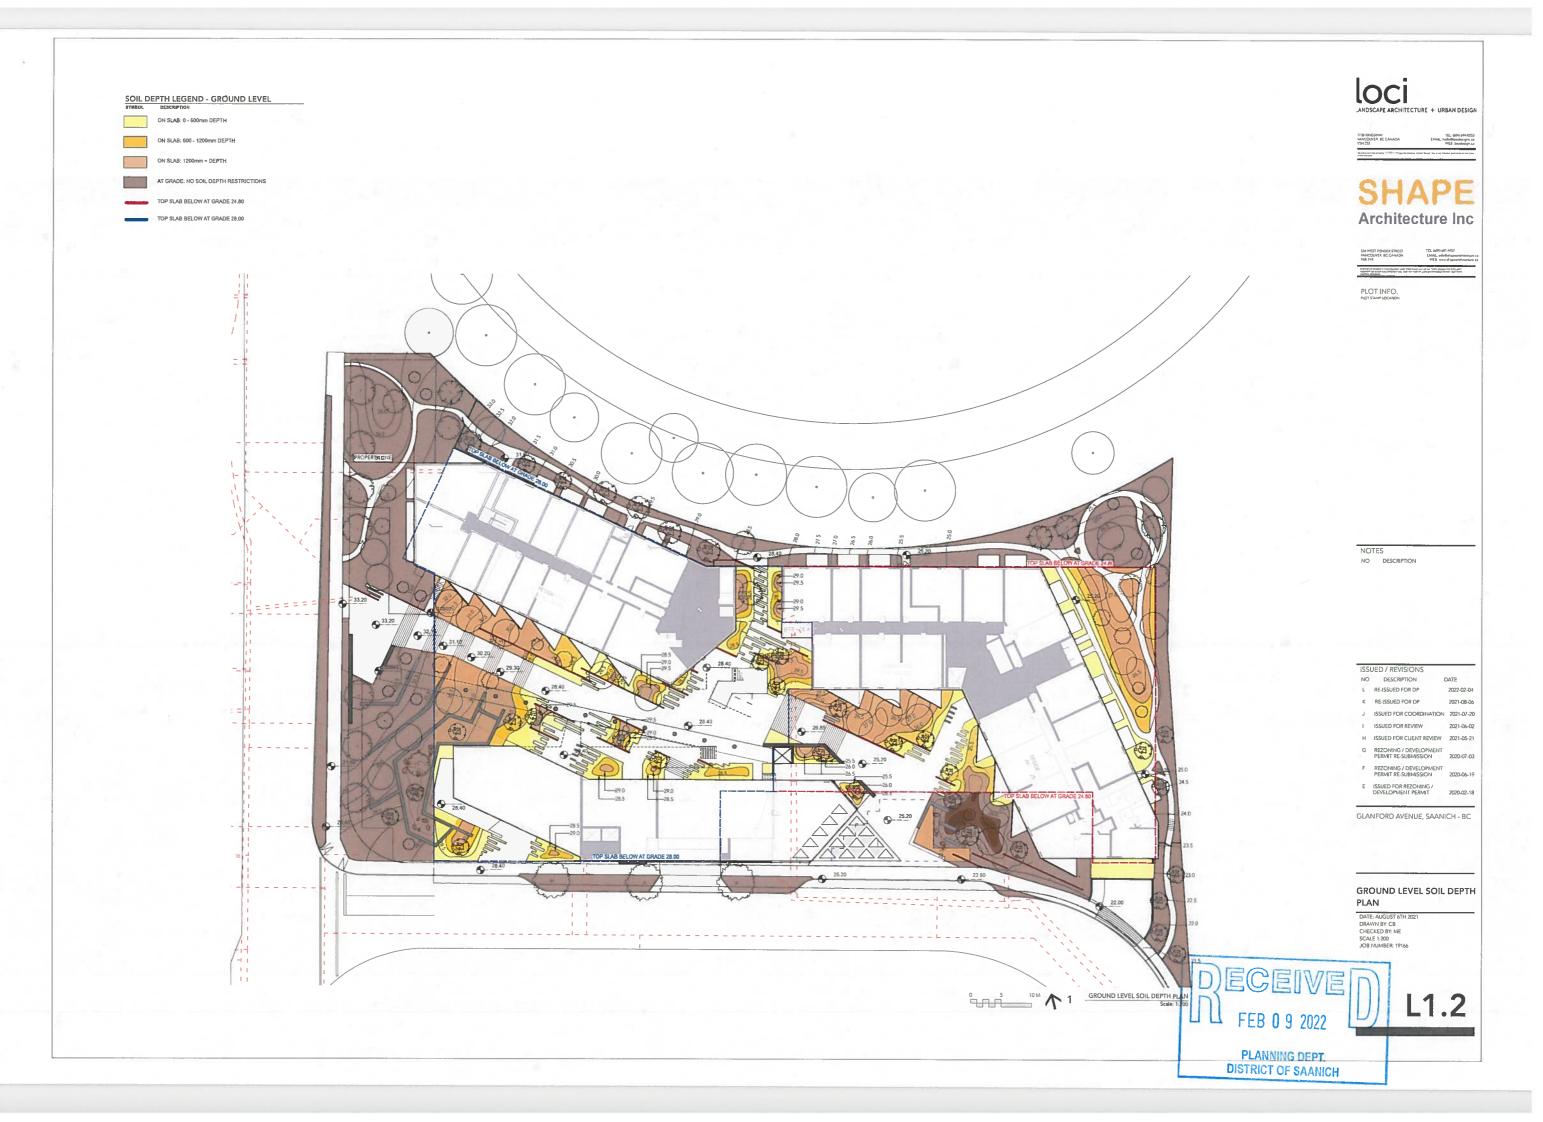

PLANTING TYPOLOGY:

GARRY OAK ECOSYSTEM (WOODLAND OR MEADOW)

- RE-STORE NATIVE ECOSYSTEM THEMATIC, PROVIDING HABITAT FOR LOCAL INSECTS AND WILDLIFE
- AUGMENT EXISTING TREES WITH REGIONALLY ADAPTED SPECIMEN ARBUTUS AND GARRY OAK TREES
- GROUNDLEVEL TEXTURE: TAPESTRIES OF WILDFLOWERS, ROCK OUTCROPS, AND INTENSE SEASONAL COLOURS BORDERED BY GRASSES AND NATIVE SHRUBS

2 ACCENT PERENNIAL GARDENS

- PROVIDE BURSTS OF COLOUR AND YEAR-ROUND TEXTURE AT KEY BUILDING ENTRIES AND VISIBLE NODES OF THE PUBLIC REALM.
- YELLOWS, BLUES, LIME GREEN AND ORANGE HUES WITH WIND-RESPONSIVE GRASSES, SEDGES AND PERENNIALS

3 RAIN GARDENS

- BIORETENTION FACILITY: NATURAL FILTRATION, TREATMENT AND STORAGE OF WATER RUNOFF FROM ON-SITE IMPERVIOUS AREAS
- POTENTIAL TO RECHARGE ON-SITE GROUNDWATER AND PLANTERS
- WATER TOLERANT PLANTS


*(OPTIONAL)

4 STREETSCAPE

- FOUNDATION PLANTING OF HARDY SHRUBS AND BROADLEAF EVERGREENS TO SOFTEN VERTICAL FACE OF TERRACED WALLS, STAIRS AND BUILDING FRONTAGE
- LARGE STREET TREES WITH SEASONAL INTEREST AND UNIFORM HABIT
- YEAR-ROUND PLANTING BUFFER TO VEHICULAR TRAFFIC

5 LAWN AREA

MOUNDED GRASS AREA FOR PASSIVE RECREATION

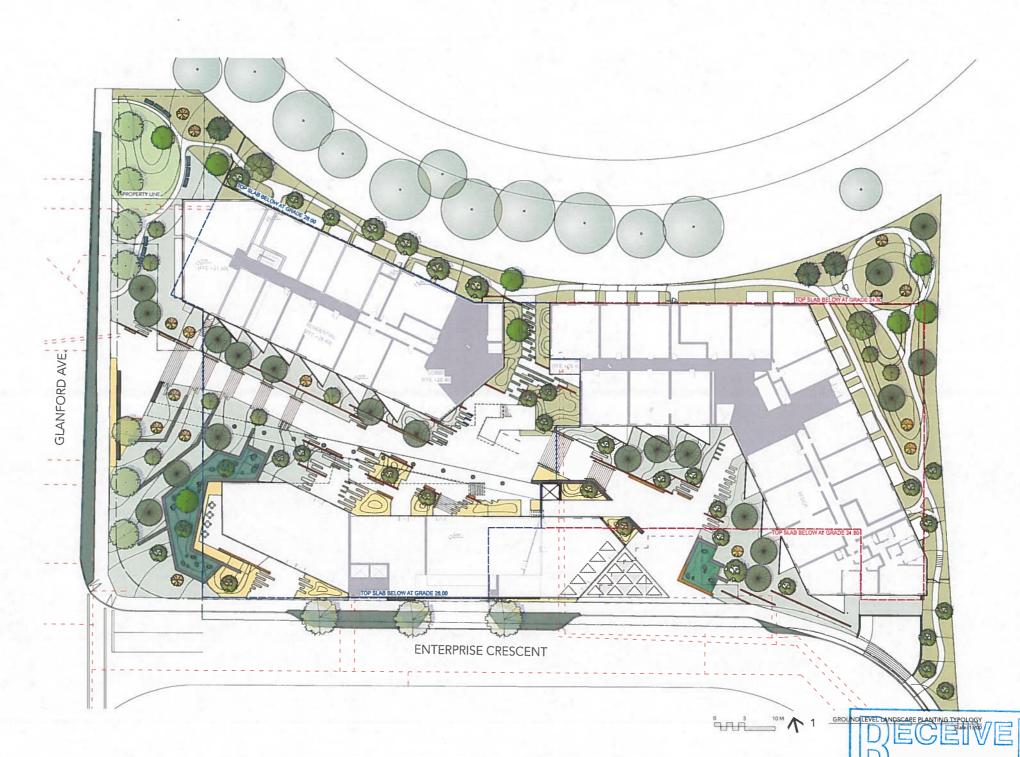



1738 KINGSINAY WANCOUVER BC CANADA VSN 253

TEL 1004 694-0053 EMAG: helleflecides-gris ca WEB, letateogris ca

SHAPE Architecture Inc

SIN WEST PENDER STREET WANCOLVER BC CANADA

P. BC CANADA EMAE, info@elegocoshoock WEB. mm shapeorthaeck

PLOT INFO.

NOTES NO DESCRIPTION

1	550	JED / REVISIONS	
	OV	DESCRIPTION	DATE
	L	RE-ISSUED FOR DP	2022-02-
	K	RE-ISSUED FOR DP	2021-08
	J	ISSUED FOR COORDINATION	2021-07
1	1	ISSUED FOR REVIEW	2021-06-
	Н	ISSUED FOR CLIENT REVIEW	2021-05
	G	REZONING / DEVELOPMENT PERMIT RE-SUBMISSION	2020-07-
i	F	REZONING / DEVELOPMENT PERMIT RE-SUBMISSION	2020-06-

ISSUED FOR REZONING / DEVELOPMENT PERMIT 2020

GLANFORD AVENUE, SAANICH - BC

GROUND LEVEL LANDSCAPE PLANTING TYPOLOGY

DATE: AUGUST 6TH 202 DRAWN BY; CB CHECKED BY: ME SCALE 1 200 JOB NUMBER: 19166

L1.3

PLANNING DEPT.
DISTRICT OF SAANICH

FEB **0** 9 2022

PLANTING LIST:

GARRY OAK ECOSYSTEM WOODLAND - SHADE-

Latin Name	Common Name	Scheduled Size	Spacing	Notes	Saanich Tree Classification
Acer macrophyllum	Big Leaf Maple	6cm cal	as shown	B&B Specimen, Multistern	Large
Arbutus menziesii	Arbutus	3cm cal	as shown	8&B Specimen	Medium
Comus nuttaliii ' Eddie's White Wi	onder' Eddie's Pacific Dogwood	5cm cal	as shown	B&B Specimen	Small
Crataegus douglasii	Black Hawthorn	7cm cal	as shown		Small
Pinus contorta var. contorta	Shore Pins	3m ht.	as shown	B&B Specimen	Medium
Pseudotsuga menziesii	Douglas Fir	3m ht.	as shown	B&B	Large
Quercus garryana	Garry Oak	3cm cal.	as shown	Mutti-Stem Specimen	Large
SHRUBS:					
Arbutus unedo 'Compacta'	Compact Strawberry Bush	#3 Pot	750mm		
Gaultheria shallon	Salal	#1 Pot	600mm		
Mahonia aquifolium	Oregon Grape Holly	#2 Pot	750mm		
Rosa gymnocarpa	Balchip Rose	#2 Pot	750mm		
PERENNIALS, GRASSES, GROUP	IDCOVER:				
Achillea millefolium	Yarrow	#1 Pot	300mm		
Festuca 'Idahoensis'	Idaho Fescue	#1 pot	450mm		
Fragaria chiloensis	Coastal Strawberry	#1 Pot	300mm		
Fragaria x ananassa	Strawberry	#1 Pat	300mm		
Fritillaria imperialis	Crown Imperial	#1 Pot	450mm		
Polystichum munitum	Western sword fern	#2 Pot	750mm		

GARRY OAK ECOSYSTEM MEADOW - SUN:

	EES:	511 - SOI4.				
	er macrophyllum	Big Leaf Maple	bem cal.	as shown	B&B Specimen, Multistem	Large
	utus menziesii	Arbutus	3cm cal	as shown	8&B Specimen	Mediun
Cor	mus nuttallii ' Eddie's White Wonde	r' Eddie's Pacific Dogwood	Sem cal	as shown	8&B Specimen	Small
	taecus douglasii	Black Hawthorn	7cm cal	as shown		Small
Pin	us contorta var. contorta	Shore Pine	3m ht.	as shown	B&B Specimen	Mediun
Pse	udotsuga menziesii	Douglas Fir	3m ht.	as shown	B&B	Large
	ercus garryana	Garry Oak	3cm cal	as shown	Mutli-Stem Specimen	Large
SHI	RUBS:					
Cor	nus sericea "Kelseyi"	Kelsey Dogwood	42 Pot	750mm		
Phil	ladelphus lewisii 'Blizzard'	Blizzard mockorange	#2 Pot	900mm		
Ros	a nutkana	Nootka Rose	#2 Pot	750mm		
San	nbucus racemosa	Red Elderberry	42 Pot	750mm		
Syn	nphoricarpos alba	Snowberry	#2 Pot	900mm		
PEI	RENNIALS, GRASSES, GROUNDO	OVER:				
Ach	illes millefolium	Yarrow	41 Pot	300mm		
Aqu	ilegia formosa	Red Columbine	#1 Pot	300mm		
Car	nassia leichtlinii	Great Camas	#1 Pot	300mm		
Col	linsia parviflora	Small-flowered blue-eyed Mary	#1 Pot	300mm		
Des	schampsia caespitosa	Tufted Hair Grass	#2 Pat	300mm		
Fes	tuca occidentalis	Green Fescue	#1 pat	300mm		
Hes	chera micrantha	Small-Flowered Alumnoot	#1 Pot	300mm		
Lilia	em columbianum	Tiger Lily	#1 Pot	300mm		
Lup	inus polyphyllus ssp. pallidipes	Large-Leaved Lupine	#1 Pot	300mm		
Ran	unculus occidentalis	Western Buttercup	#1 Pot	300mm		

ARDEN:				
TREES				
Crataegus douglasii	Black Hawthorn	7cm cal	as shown	Small
Cornus nuttallii ' Eddie's White	e Wonder' Eddie's Pacific Dogwood	5cm cal	as shown B&B Specimen	Small
PERENNIALS, GRASSES, GR	OUNDCOVER:			
Carex densa	Dense Sedge	#1 pet	600mm	
Iris versicolar	Purple Iris	#1 Pol	300mm	
Juncus effusus	Soft Common Rush	#1 Pot	600mm	
	TREES Crataegus douglasii Cornus nuttallii * Eddie's White PERENNIALS, GRASSES, GR Carex densa Iris versicolor	TREES: Cratasegus douglasii Black Hawthom Cornus nuttallia ' Eddie's White Wonder' Eddie's Pacific Dogwood PERENNIALS, GRASSES, GROUNDCOVER: Carex densa Iris versicolor Purple Ins	TREES. Cratasegus douglasii Black Hawthom 7cm cal. Cornus nuralla "Edde's White Worder' Edde's Pacific Dogwood Scm cal. PERENNIALS, GRASSES, GROUNDCOVER: Carex densa Dense Sedge #1 pot fire versicoler Purple iris #1 Pot	TREES Cratasegus douglasii Black Hawthom 7cm cal as shown Cornus nuttallia 'Eddie's White Wonder' Eddie's Pacific Dogwood 5cm cal as shown 8&8 Specimen PERENNIALS, GRASSES, GROUNDCOVER: Carex densa Dense Sedge 41 pot 600mm Iris versicolor Purple Ins 41 Pot 300mm

STREE	T SCAPE:				
	TREES:				
	Frazinus Latifolia	Oregon Ash	6cm cal	as shown B&B Specimen	Large
	Crataegus x lavallei	Lavalle Hawthorn	7cm cal	as shown	Small
	SHRUBS:				
	Escallonia 'Pink Princess'	Escallonia	#2 Pot	600mm	
	Lonicera nitida	Wilson's honeysuckle	#2 Pot	750mm	
	Rosa nutkana	Nootka Rose	≉2 Pot	750mm	
	PERENNIALS, GRASSES, GROU	NDCOVER:			
	Helictotrichon sempervirens	Blue Oat Grass	#2 pat	750mm	

PRELIMINARY PLANT IMAGES:

GARRY OAK ECOSYSTEM WOODLAND - SHADE:

























Architecture Inc

PLOT INFO.

GARRY OAK ECOSYSTEM MEADOW - SUN:





















ACCENT PERENNIAL GARDENS:





















NOTES NO DESCRIPTION

-	ISSUED / REVISIONS	_
424	NO DESCRIPTION	
£1.3	L RE-ISSUED FOR DP	
	K RE-ISSUED FOR DP	
	J ISSUED FOR COORD	Įħ.
	I ISSUED FOR REVIEW	
TO SERVICE STATE OF THE PARTY O		

RAIN GARDEN:

STREET SCAPE











PERENNIALS, GRASSES, GROUNDCOVER:













DISTRICT OF SAANICH


GLANFORD AVENUE, SAANICH - BC

LANDSCAPE PLANT LIST AND

PALETTE

DATE AUGUST 6TH 202° DRAWN BY, CB CHECKED BY ME SCALE 1:200 JOB NUMBER: 19166

2022-02-04

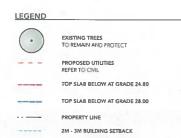

CISTERN - REFER TO CIVIL

OFFSETS:

-SMALL TREES 2M FROM BUILDING LARGE/MEDIUM TREES 3M FROM BUILDING -LARGE/MEDIUM TREES 1M FROM PROPERTY LINE -ALL TREES 1.5M FROM UTILITES


NOTE:

-REFER TO L1.4 FOR PLANT SPECIES, SPACING AND SIZES. -ALL TREES RECEIVE AUTOMATIC IRRIGATION ON AND OFF SITE.

-IRRIGATION FOR THE BOULEVARD TREES SHALL BE PROVIDED BY THE PROPERTY OWNER FROM THEIR IRRIGATION SYSTEM ON ITS OWN IRRIGATION ZONE SUITABLE FOR TREE WATERING SEPARATE TO THE SURROUNDING LANDSCAPE. -TOTAL # OF EXISTING TREES: 48 (AS PER ARBORIST REPORT) -THE TOTAL OF TREES TO BE REMOVED: 48 (AS PER ARBORIST REPORT) -THE TOTAL OF EXISTING XTREES TO REMAIN: D (AS PER ARBORIST REPORT) -THE TOTAL OF PROPOSED TREES: 100 -PROPOSED TREE REPLECEMENT RATIO - 3:1

OVERALL TREES LIST:

Sym	bols Latin Name	Common Name	Scheduled Size	Quantity	Saanich T	ree Classificat
	TREES:					
6	Acer macrophyllum	Big Leaf Maple	6cm cal	2	Large	
6	Arbutus menziesii	Arbutus	3cm cal.	15	Medium	•
6	Cornus nuttallii ' Edd e's White V	Vonder' Eddie's Pacific Dogwood	5cm cal	34	Small	0
	Crataegus douglas i	Black Hawthorn	7cm cal.	8	Small	0
	Pinus contorta var contorta	Shore Pine	3m ht.	20	Medium	•
	Pseudotsuga menziesii	Douglas Fir	3m ht.	3	Large	0
	Quercus garryana	Garry Oak	3cm cal	8	Large	•
1	Fraxinus Latifolia	Oregon Ash	6cm cal.	3	Large	0
(Crataegus x lavallei	Lavalle Hawthorn	7cm cal.	7	Small	0

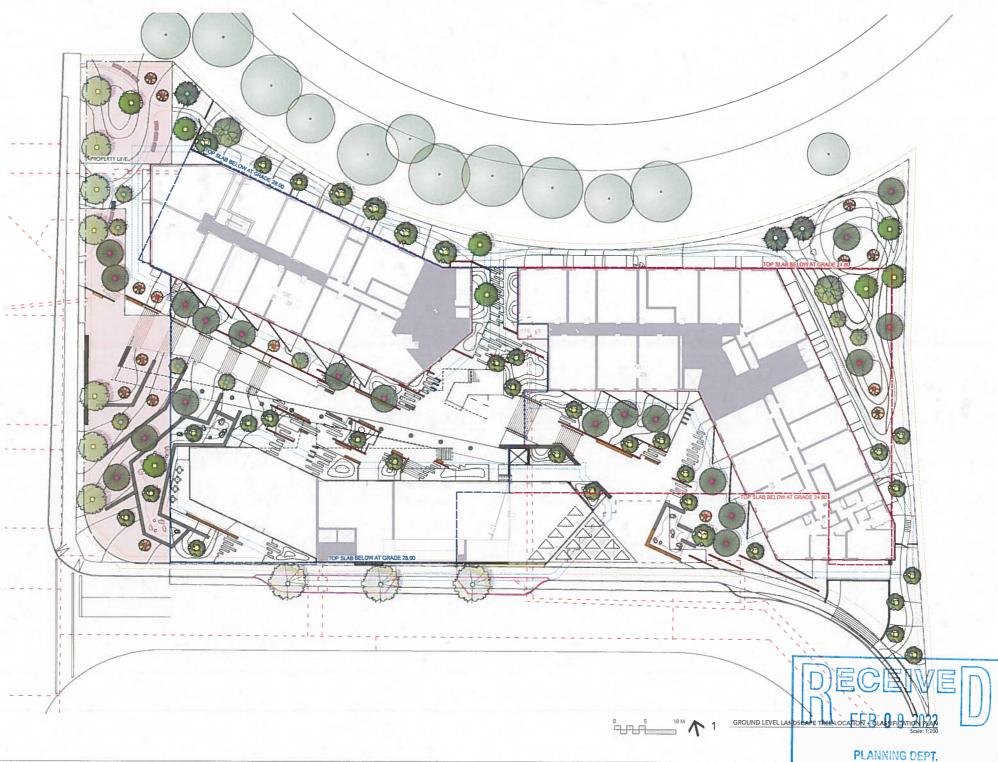

Architecture Inc

PLOT INFO.

NOTES


NO DESCRIPTION L RE-ISSUED FOR DP 2022-02-04 K RE-ISSUED FOR DP 2021-08-06 H ISSUED FOR CHENT REVIEW 2021-05-21 E ISSUED FOR REZONING / DEVELOPMENT PERMIT 2020-02:18

GLANFORD AVENUE, SAANICH - BC

GROUND LEVEL TREE LOCATION + CLASSIFICATION

DATE AUGUST 6TH 2021 DRAWN BY CB CHECKED BY ME SCALE 1:200 JOB NUMBER: 19166

DISTRICT OF SAANICH

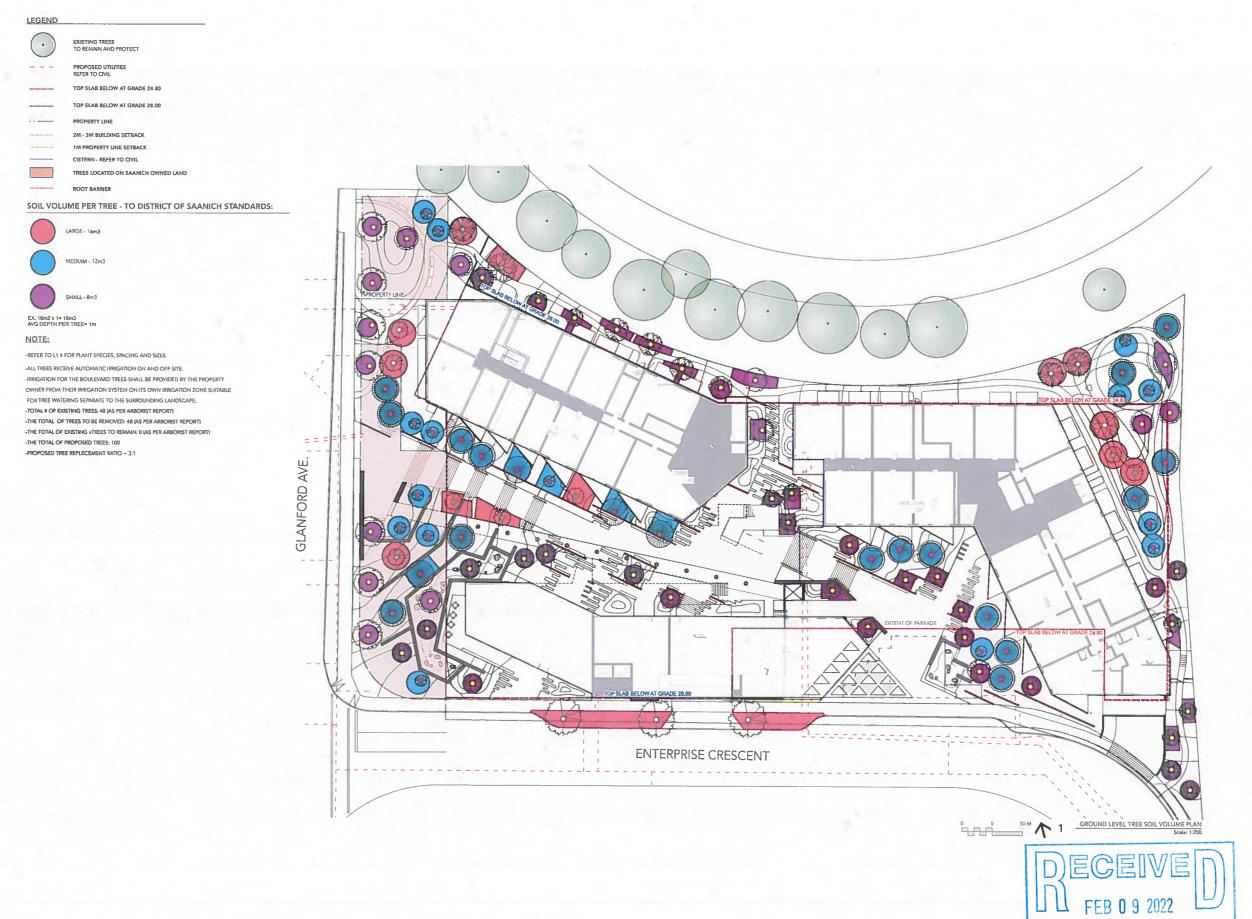

LOCI
ANDSCAPE ARCHITECTURE + URBAN DESIGN

1738 KINGSPIAT VANCOUVER BC CANADA VSN 253

> SHAPE Architecture Inc

ANCOLYSE SC CAMADA

MICOLYSE SC CAMADA

MIST PENDER STREET

TO

THE TYPE

IC CANADA EMAL, infederace-ordered WEB, more strapposity/step

PLOT INFO

NOTES

NO DESCRIPTION

ISSUED / REVISIONS
NO DESCRIPTION
L RE-ISSUED FOR DP

 K
 REJSSUED FOR DP
 2021-08-06

 J
 ISSUED FOR COORDINATION
 2021-07-20

 I
 ISSUED FOR REVIEW
 2021-06-02

 H
 ISSUED FOR CLIENT REVIEW
 2021-05-21

G REZONING / DEVELOPMENT
PERMIT RE-SUBMISSION

F REZONING / DEVELOPMENT

GLANFORD AVENUE, SAANICH - BC

GROUND LEVEL TREE SOIL VOLUME PLAN

DATE AUGUST 6TH 2021 DRAWN BY: CB CHECKED BY: ME SCALE 1:200 JOB NUMBER: 19166

PLANNING DEPT.

DISTRICT OF SAANICH

L1.6



738 CINGSVIAT RACOUNER, BC CANADA SN 253 TEL: 1604 694-0253 EMAR, hellofflecates-gin ca WEB, localways-ca

SHAPE Architecture Inc

SAM WEST PENDER STREET WHICOLYER BC CANADA VIB IVE TEL (60%) 687-6657 ESCALL infelliphoperatherchira co WER. ==== shapeorthrochira co

PLOT INFO.

NOTES

O DESCRIPTION

ISSUED / REVISION

NO DESCRIPTION

REJISSIED FOR DR

RE-ISSUED FOR DP 2021-0 ISSUED FOR COORDINATION 2021-0

ISSUED FOR CLIENT REVIEW

PERMIT RE-SUBMISSION

REZONING / DEVELOPMENT

PERMIT RE-SUBMISSION

E ISSUED FOR REZONING / DEVELOPMENT PERMIT

GLANFORD AVENUE, SAANICH - BC

GLANFORD FRONTAGE PERSPECTIVE

DATE AUGUST 6TH DRAWN BY CB CHECKED BY ME SCALE 1:200

L2.0



DECEIVE D



ANDSCAPE ARCHITECTURE + URBAN DESIGN

Architecture Inc

PLOT INFO.

NO DESCRIPTION

L RE-ISSUED FOR DP K RE-ISSUED FOR DP

PASEO MAIN STAIRS
PERSPECTIVE

DATE AUGUST 6TH 2021
DRAWN 8° C'8
CHECKED 8° ME
SCALE 1200
JOB NUMBER: 19166

FEB 0 9 2022



NOTES NO DESCRIPTION

GLANFORD AVENUE, SAANICH - BC

PUBLIC PASEO PERSPECTIVE



DECEIVE U FEB 0 9 2022



ISSUED / REVISIONS NO DESCRIPTION

L RE-ISSUED FOR DP

GLANFORD AVENUE, SAANICH - BC

PASEO LOWER STAIRS PERSPECTIVE

DATE AUGUST 6TH 202 DRAWN BY: CB CHECKED BY: ME SCALE 1.200 JOB NUMBER: 19166

L2.3



DECEIVE FEB 0 9 2022



PLOT INFO

ISSUED / REVISIONS

L RE-ISSUED FOR DP

GLANFORD AVENUE, SAANICH - BC

LOWER TERRACE
PERSPECTIVE
DATE: AUGUST 6TH 2021
DRAWN 8TY CB
CHECKED BY ME
SCALE 1200
JOB NUMBER: 19166







TEL MOR MET-4452 EMAIL, infoSylogousyth WEB, man allapourphi

PLOT INFO.

NOTES NO DESCRIPTION

GLANFORD AVENUE, SAANICH - BC

LOWER RAIN GARDEN PERSPECTIVE

L2.5



PLOT INFO

NOTES NO DESCRIPTION

ISSUED / REVISIONS NO DESCRIPTION

L RE-ISSUED FOR DP

2022-02-04

GLANFORD AVENUE, SAANICH - BC

COMMERCIAL PATIO AND ENTRY PERSPECTIVE

L2.6



DECEIVE N FFB 0 9 2022 PLANNING DEPT. DISTRICT OF SAANICH



PLOTINFO.

NOTES NO DESCRIPTION

ISSUED / REVISIONS NO DESCRIPTION

K RE-ISSUED FOR DP J ISSUED FOR COORDINATION 2021-07-20

GLANFORD AVENUE, SAANICH - BC

GLANFORD AND ENTERPRISE FEATURE CORNER PERSPECTIVE DATE. AUGUST 6TH 2021 DRAWN BY CB CHECKED BY ME SCALE I 200 JOB NUMBER: 19166



DECEIVE U FEB 0 9 2022