

GENERAL NOTES:

1. ALL WORK AND MATERIALS ARE TO BE IN ACCORDANCE WITH THE LATEST EDITIONS OF THE CORPORATION OF THE DISTRICT OF SAANICH ENGINEERING SPECIFICATIONS, THE BRITISH MUNICIPAL CONSTRUCTION DOCUMENTS (MBCD) PLATINUM EDITION AND THE BRITISH COLUMBIA PLUMBING CODE.
2. BUILDING AND PLUMBING PERMITS WILL BE REQUIRED FOR ALL WORK.
3. THE ENGINEER SHALL BE ADVISED 48 HOURS PRIOR TO COMMENCEMENT OF WORK.
4. CONTRACTOR TO COMPLY WITH ALL APPLICABLE MINISTRY OF ENVIRONMENT AND DEPARTMENT OF FISHERIES & OCEANS CANADA REQUIREMENTS AT ALL TIMES DURING CONSTRUCTION.
5. CONTRACTOR TO CONFIRM LOCATION OF EXISTING UTILITIES AT ALL CROSSINGS AND CONNECTIONS AND REPORT ANY DISCREPANCIES TO THE ENGINEER PRIOR TO CONSTRUCTION.
6. CONTRACTOR TO CONFIRM THAT ELEVATION, LOCATION AND GRADIENT OF ASPHALT MATCH EXISTING PRIOR TO PLACEMENT OF ASPHALT OR CONCRETE.
7. CONTACT THE DISTRICT OF SAANICH ENGINEERING DEPARTMENT 24 HOURS PRIOR TO BLASTING ON-SITE. PROVIDE BLASTING PROCEDURES IN ACCORDANCE WITH SECTION 31.23.11 OF THE MBCD. BLASTING CONTRACTOR TO HAVE VALID BLASTING PERMIT.
8. CONTACT TO NOTIFY ALL HOUSING AFFECTED BY WORKS 4 WEEKS PRIOR TO CONSTRUCTION.
9. REPAIR AND/OR REPLACE ALL INFRASTRUCTURE/PRIVATE PROPERTY AND BOUNDARIES DAMAGED OR REMOVED DURING CONSTRUCTION TO BETTER THAN OR EQUAL TO PRE-CONSTRUCTION CONDITION.
10. ENSURE THE CURRENT MUNICIPAL BYLAWS, CRIMINAL DISTURBANCE PRACTICE AND PROCEDURES ARE FOLLOWED. NOTIFY THESE PROPERTY OWNERS WHO WILL BE AFFECTED BY CONSTRUCTION 48HRS BEFORE BEGINNING WORKS.
11. CONTRACTOR TO BE REGISTERED WITH WORKSAFE BC.
12. CONTRACTOR TO ABIDE BY SITE REGULATIONS AS NOTED IN CONTRACT DOCUMENTS AND ON CONSULTATIVE DRAWINGS.
13. CONTACT THE DISTRICT OF SAANICH PARKS DEPARTMENT PRIOR TO WORKING IN AND AROUND TREES.
14. ALL TREES NOT BEING REMOVED IN THE CONSTRUCTION AREA SHALL BE PROTECTED AS PER DISTRICT OF SAANICH TREE PROTECTION BYLAW NO. 8272. CARE TO BE TAKEN TO REMOVE AS MANY TREES AS POSSIBLE.
15. SAANICH VEHICULAR AND PEDESTRIAN ACCESS ALONG CEDAR HILL ROAD AND CEDAR HILL CROSS ROAD ROAD DURING CONSTRUCTION.
16. MAINTAIN ALL MARKERS, BARRIERS, HYDRO MARKERS, ETC. TO MATCH NEW CONSTRUCTION.
17. ALL LOCATIONS AND ELEVATIONS OF EXISTING UTILITIES SHOWN ARE APPROXIMATE ONLY AND SHOULD BE CONFIRMED BY USE OF A PIPE LOCATOR AND MANUAL DIGGING. ALL OR ANY STRUCTURES NOT NECESSARILY SHOWN.
18. ALL ELEVATIONS ARE REFERENCED TO GEODETIC DATUM CHYBESIC AND DERIVED FROM MONUMENT 886-0488, ELEVATION 30.855M.
19. DATA SOURCES:
 - TOPOGRAPHIC SURVEY COMPLETED BY EXPLORER LAND SURVEYING INC. IN MARCH 2017.
 - ELEVATS PROVIDED BY THE DISTRICT OF SAANICH, AND BC 1 CALL.

STORM DRAIN NOTES:

1. ALL STORM SEWERS TO BE 300mm PVC SOLIDS, UNLESS OTHERWISE NOTED. STORM SEWER SERVICE CONNECTIONS TO BE PVC SOLIDS.
2. CATCH BASIN LEADS TO BE 300mm PVC SOLIDS, UNLESS OTHERWISE NOTED.
3. ENSURE ALL EXISTING DRAIN SYSTEMS REMAIN AS IS DURING CONSTRUCTION. RECONNECT EXISTING SERVICES TO PROPOSED MAINS AS REQUIRED.
4. ENSURE 1.00m CLEAR HORIZONTAL SEPARATION BETWEEN STORM DRAIN MAINS AND CROSSLINGS 90° IN DIA. STEEL WATERMAIN.
5. ALL PIPE BEDDING AND BACKFILL AS PER MBCD S17. DISEL NO. C4.
6. ALL STORM DRAIN PIPE ALIGNMENTS SHOWN NOT PARALLEL TO THE ROAD ALLOWANCE ARE DESIGNED TO CONFORM TO THE MINIMUM PIPE RADIUS AND DEFLECTION REQUIREMENTS AS SPECIFIED BY THE PIPE MANUFACTURER.
7. WHERE A TRENCH IS LARGER THAN 1.00m OF THE EDGE OF A ROAD, PARKING AREA OR DRIVEWAY, USE PITBULL GRAVEL BACKFILL FROM THE TOP OF THE PIPE CUSHION TO THE TOP OF THE ROAD, PARKING AREA OR DRIVEWAY SURFACE.
8. COMPACT TRENCH BACKFILL, ROAD BASE AND DRIVEWAY BASE TO 98% MODIFIED PROCTOR DENSITY.
9. STORM DRAIN PIPES TO BE VIDEO INSPECTED BY CONTRACTOR AT THEIR EXPENSE.
10. LOCATION OF STORM DRAIN SERVICE CONNECTIONS AT MAIN ARE BASED ON PIPE VIDEO INSPECTION REPORTS PROVIDED BY VICTORY DRAIN.

SANITARY SEWER NOTES:

1. ALL SANITARY SERVICES ARE TO BE 150mm PVC SOLIDS UNLESS OTHERWISE NOTED.
2. ENSURE ALL EXISTING SANITARY SYSTEMS REMAIN IN USE DURING CONSTRUCTION. RECONNECT EXISTING SERVICES TO PROPOSED MAINS AS REQUIRED.
3. ALL PIPE BEDDING AND BACKFILL AS PER MBCD S17. DISEL NO. C4.
4. ALL SANITARY SEWER ALIGNMENTS SHOWN NOT PARALLEL TO THE ROAD ALLOWANCE ARE DESIGNED TO CONFORM TO THE MINIMUM PIPE RADIUS AND DEFLECTION REQUIREMENTS AS SPECIFIED BY THE PIPE MANUFACTURER.
5. WHERE A TRENCH IS LARGER THAN 1.00m OF THE EDGE OF A ROAD, PARKING AREA OR DRIVEWAY, USE PITBULL GRAVEL BACKFILL FROM THE TOP OF THE PIPE CUSHION TO THE TOP OF THE ROAD, PARKING AREA OR DRIVEWAY SURFACE.
6. COMPACT TRENCH BACKFILL, ROAD BASE AND DRIVEWAY BASE TO 98% MODIFIED PROCTOR DENSITY.
7. SANITARY SEWER TO BE VIDEO INSPECTED BY CONTRACTOR AT THEIR EXPENSE.
8. LOCATION OF SANITARY SEWER SERVICE CONNECTIONS AT MAIN ARE BASED ON PIPE VIDEO INSPECTION REPORTS PROVIDED BY VICTORY DRAIN.

WATER NOTES:

1. CONNECTION TO EXISTING BY DISTRICT OF SAANICH FORCES AT DEVELOPERS EXPENSE.

ROAD NOTES:


1. ROAD RESTORATION AS PER DISTRICT OF SAANICH S17. DISEL NO. C06S.
2. CONTRACTOR TO ENSURE EXISTING MONUMENTS OR BORN PIPES IN DANGER OF DISTURBANCE ARE TO BE REFERENCED AND, IF DISTURBED, BE REPLACED BY A BOLT AT THE CONTRACTORS EXPENSE.

SHALLOW UTILITY NOTES:

1. EXISTING BC HYDRO, TELUS, SHAW CABLE AND FORTIS BC INFRASTRUCTURE INFORMATION SHOWN ON DRAWINGS IS SCHEMATIC AND FOR INFORMATION ONLY.
2. CONTACT BC 1 CALL AT 1-800-474-8888 A MINIMUM OF 72 HOURS PRIOR TO CONSTRUCTION.
3. CONTACT BC HYDRO, TELUS, SHAW CABLE AND FORTIS BC 48 HOURS PRIOR TO THE START OF ANY EXCAVATION.

LIST OF DRAWINGS:

DEW. No.	DESCRIPTION
C100	KEY PLAN, LOCATION PLAN, DRAWING LIST AND GENERAL NOTES
C200	SITE SERVICES PLAN
C301	DRAINAGE PLAN
C400	STORM WATER MANAGEMENT PLAN

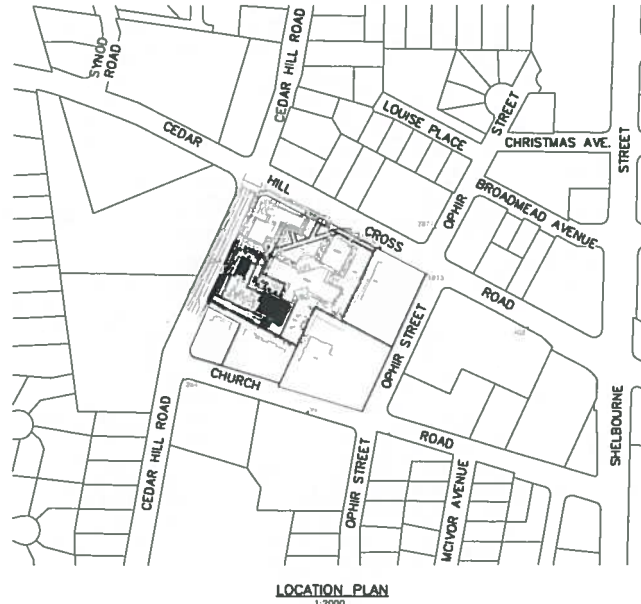

KEY PLAN
 NTS
 LEGAL DESCRIPTION
 LOT 1 SECTIONS 39 AND 40, VICTORIA DISTRICT, PLAN 31103
 EXCEPT PART IN PLAN VPB1393 AND LOT 2, SECTIONS 39
 AND 40, VICTORIA DISTRICT, PLAN 31103
 3738 CEDAR HILL ROAD
 1525 CEDAR HILL CROSS ROAD





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 2021-04-26

DEVELOPMENT PERMIT
 APRIL 26, 2021

THE DISTRICT OF SAANICH - April 23, 2021 / J:\Projects\2020-001 Luthur Court Interpersonal Use\NAC Drawings\2020-001 Luthur Court Interpersonal Use

CONFIRM UNDERGROUND LOCATIONS WITH UTILITY COMPANIES	LEGEND	REVISIONS	REVISIONS APPROVED			DESIGN APPROVED			DISTRICT OF SAANICH	FILE
			REVISION # 1	REVISION # 2	REVISION # 3	Approved By	Date	Signed		
THE LOCATION AND DEPTH OF ALL EXISTING UNDERGROUND INFRASTRUCTURE SHOWN ON THIS DRAWING MAY NOT BE ACCURATE. THE CONTRACTOR SHALL VERIFY THE ACTUAL, HORIZONTAL AND VERTICAL LOCATIONS MUST BE CONFIRMED PRIOR TO THE START OF ANY CONSTRUCTION.	Existing Municipal Infrastructure Proposed Municipal Infrastructure Existing External U/G Utilities Proposed External U/G Utilities Street Lighting Pole Mount Pole Top Existing Traffic Signal Proposed Traffic Signal Existing Monument Proposed Monument Existing Transverse Hub Proposed Transverse Hub Existing Gas Valve Proposed Gas Valve Existing Water Meter Proposed Water Meter	1. 0 2. 5 3. 4 4. 3 5. 2 6. 1	Approved Date Signed	Approved Date Signed	Approved Date Signed	Design Engineer Manager of Design or Designer Professional Designer Professional Designer	Date Date Date	LUTHER COURT - INTERPERSONAL HOUSING PROJECT KEY PLAN, LOCATION PLAN, DRAWING LIST AND GENERAL NOTES S.M. : 2020 08 03 Drawing No. : 2020-001-001-001 Scale: 1/4" = 1'-0"	5299-001 C100	

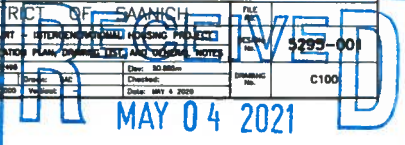

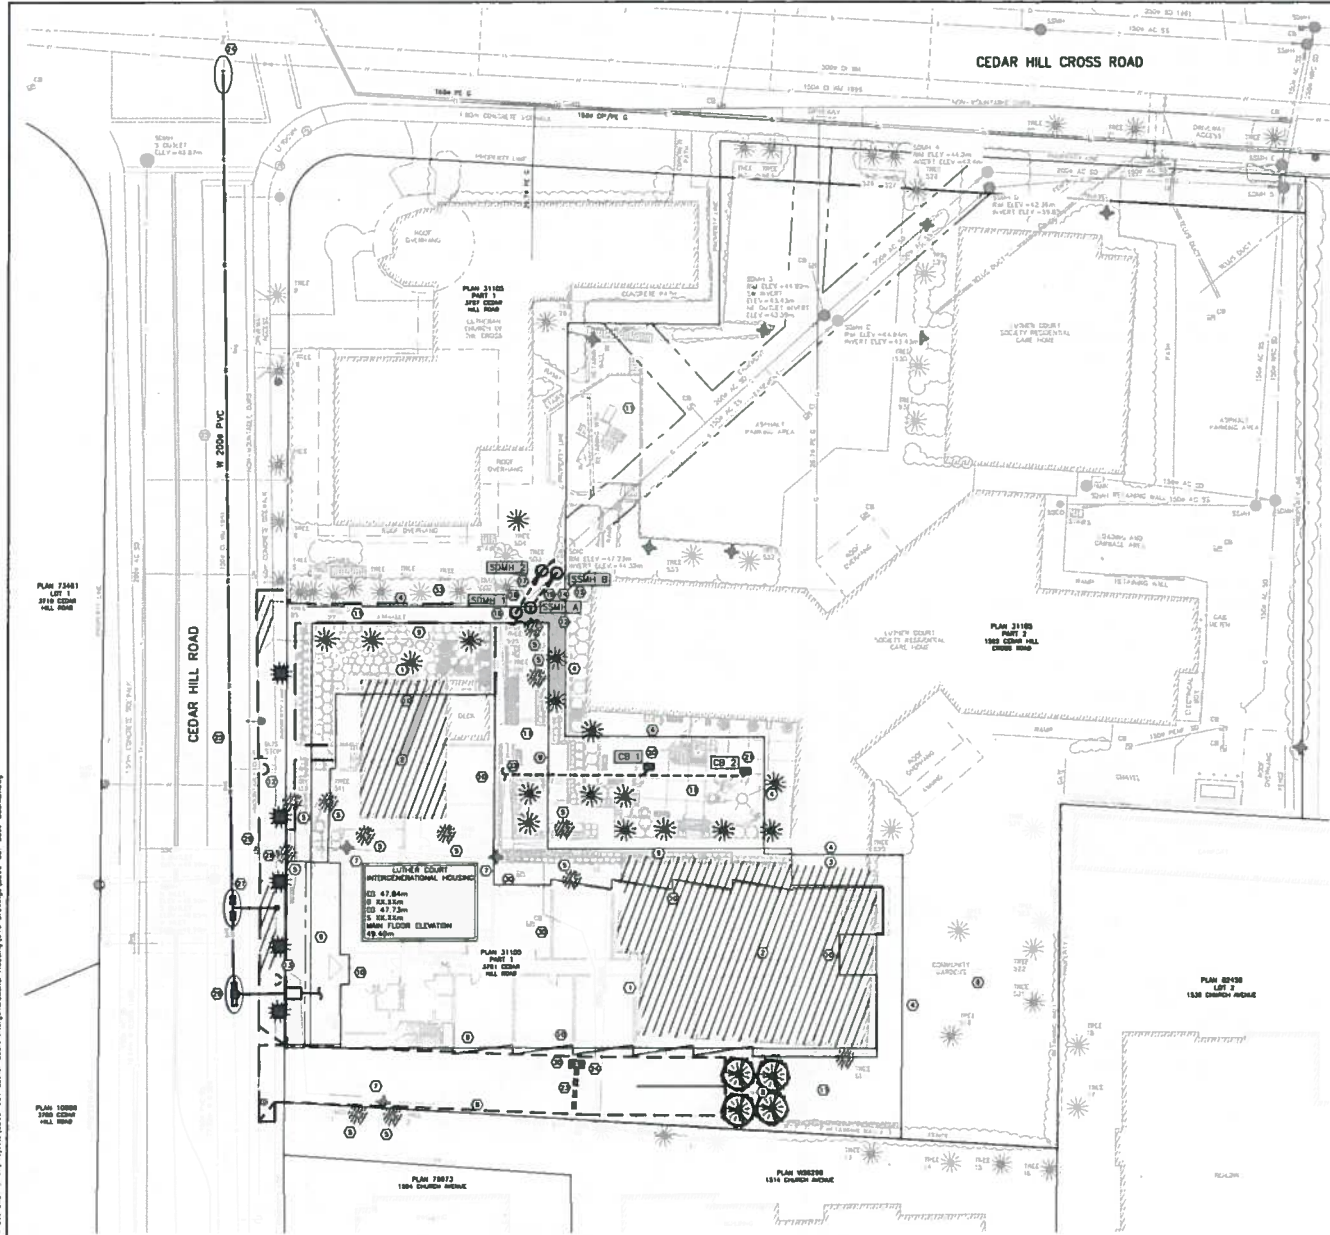

- NOTES:**
- FOR SITE DEMOLITION, SEE ARCHITECTURAL DESIGN DRAWINGS.
 - FOR SPECIAL NOTES SEE SHEET C100.

DETAILED CONSTRUCTION NOTES:

- PORTION OF EXISTING BUILDING TO BE REMOVED
- SITE DEMOLITION. SEE ARCHITECTURAL DESIGN DRAWINGS FOR DETAILS.
- GROUND FLOOR AND BRIDGE CONNECTION TO EXISTING BUILDING. SEE ARCHITECTURAL DESIGN DRAWINGS FOR DETAILS.
- PROPOSED PARCEL BOUNDARY
- EXISTING TREE TO BE REMOVED (TYP.)
- EXISTING COMMUNITY GARDENS TO BE RETAINED
- EXISTING LAMP STANDARDS TO BE REMOVED
- WOOD FENCE AND LANDSCAPE AREAS. SEE LANDSCAPE DESIGN DRAWINGS FOR DETAILS.
- PARKING LEVEL OUTLINE
- MAIN FLOOR BUILDING OUTLINE
- ON-SITE SIDEWALK, RAMP, COURTYARD AND LANDSCAPING. SEE LANDSCAPE DESIGN DRAWINGS FOR DETAILS.
- EXISTING WATER SERVICE TO BE CAPPED AND ABANDONED BY D&S FORCES AT DEVELOPER'S EXPENSE.
- EXISTING SANITARY SERVICE TO BE CAPPED AND ABANDONED BY D&S FORCES AT DEVELOPER'S EXPENSE.
- SANITARY MANHOLE A AS PER UNCCO STD. DWG. NO. ST. MLEY-ELEV-TO BE CONFIRMED DURING CONSTRUCTION
OUTLET ELEV-TO BE CONFIRMED DURING CONSTRUCTION
- SANITARY MANHOLE B AS PER UNCCO STD. DWG. NO. S1. MLEY-ELEV-TO BE CONFIRMED DURING CONSTRUCTION
OUTLET ELEV-TO BE CONFIRMED DURING CONSTRUCTION
- STORM DRAIN MANHOLE 1 AS PER UNCCO STD. DWG. NO. ST. MLEY-ELEV-44.47m
OUTLET ELEV-44.44m
- STORM DRAIN MANHOLE 2 AS PER UNCCO STD. DWG. NO. ST. MLEY-ELEV-44.30m
OUTLET ELEV-44.27m
- ELKH @ 1.00m TO 2000 PVC TO BE INTO EXISTING SD
- ELKH @ 1.00m TO 1500 PVC TO BE INTO EXISTING SS
- CATCH BASIN 1 AS PER D&S STD. DWG. NO. S2153
RM ELEV-38.32m
MV. ELEV-38.32m
- CATCH BASIN 2 AS PER D&S STD. DWG. NO. S2153
RM ELEV-38.32m
MV. ELEV-38.32m
- 1500 STORM DRAIN SERVICE CONNECTION TO BE INTO BUILDING SYSTEM
- ELKH AND HEXADRAM TRENCH DRAIN OR APPROVED EQUIVALENT
- CONCRETE OIL/WATER SEPARATOR AS PER D&S STD. DWG. NO. DCS13, OR APPROVED EQUIVALENT. TO DISCHARGE TO BUILDING SYSTEM
- REPLACE EXISTING 1500 ID WATERMAIN WITH 800mm ID 2000 PVC. CONNECTIONS BY D&S FORCES AT DEVELOPER'S EXPENSE.
- 1500 WATER SERVICE CONNECTION AND CHAMBER BY D&S FORCES AT DEVELOPER'S EXPENSE.
- 1500 IRRIGATION WATER SERVICE CONNECTION AS PER D&S STD. DWG. NO. IWS13 BY D&S FORCES AT DEVELOPER'S EXPENSE. C/P METER AND BACKFLOW PREVENTER. TO BE IN CONCRETE METER BOX C/P CAST IRON COVER WITH 450 HOLE FOR TONGUE READ ADAPTER
- FIRE DEPARTMENT CONNECTION ON SICH FOOTPRINT. SEE MECHANICAL AND ARCHITECTURAL DESIGN DRAWINGS FOR DETAILS.
- EXISTING CATCH BASIN TO BE REINSTATED
- EXISTING CATCH BASIN TO BE REMOVED AND DISPOSED OF OFF-SITE.
- FORTS BC CONNECTION LOCATION AND SIZE TO BE CONFIRMED BY FORTS.
- ELECTRICAL SERVICE. SEE ELECTRICAL DESIGN DRAWINGS FOR DETAILS.
- EXISTING MEMORIAL GARDEN AREA. AREA TO BE PROTECTED AND GREAT CARE GIVEN WHEN WORKING IN THIS AREA.


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 Computer Aided Design & Drafting
 Surveying & Mapping



DEVELOPMENT PERMIT
 APRIL 20 2021

DISTRICT OF SAANICH PERMIT NO. 5295-001
LUTHER COURT INTERDEVELOPMENTAL HOUSING PROJECT
 SITE DESIGN PLAN

B.M.: MCM 80-848 Date: 05.08.20
 Design: TRJ Drawn: SAC Checked: AJH
 Scale: 1:500 Project: 15-20 Version: 1

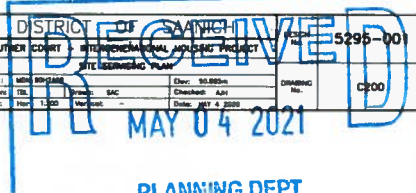


CONFIRM UNDERGROUND LOCATIONS WITH UTILITY COMPANIES THE LOCATION AND ELEVATION OF THE EXISTING UNDERGROUND INFRASTRUCTURE SHOWN ON THIS DRAWING MAY NOT BE ACCURATE OR COMPLETE. THE ACTUAL HORIZONTAL AND VERTICAL LOCATIONS MUST BE CONFIRMED PRIOR TO THE START OF ANY CONSTRUCTION.	COMMENTS	STAMP	REVISIONS	APPROVED BY	SIGN	DATE
			1			
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			6			

THE DISTRICT OF SAANICH, MAY 23, 2021 / J:\Projects\15295-001 Luther Court Interdevelopmental Housing\15295-001 Inter-Service.dwg

- NOTES:**
- FOR SITE DEMOLITION, SEE ARCHITECTURAL DESIGN DRAWINGS
 - FOR GENERAL NOTES SEE SHEET C100.

DETAILED CONSTRUCTION NOTES:

- PORTION OF EXISTING BUILDING TO BE REMOVED
- SITE DEMOLITION, SEE ARCHITECTURAL DESIGN DRAWINGS FOR DETAILS
- GROUND FLOOR AND BRIDGE CONNECTION TO EXISTING BUILDING, SEE ARCHITECTURAL DESIGN DRAWINGS FOR DETAILS
- PROPOSED PARCEL BOUNDARY
- EXISTING TREE TO BE REMOVED (TYP.)
- EXISTING COMMUNITY GARDENS TO BE RETAINED
- EXISTING LAMP STANDARDS TO BE REMOVED
- WOOD FENCE AND LANDSCAPE AREAS, SEE LANDSCAPE DESIGN DRAWINGS FOR DETAILS
- PARKING LEVEL OUTLINE
- MAIN FLOOR BUILDING OUTLINE
- ON-SITE SIDEWALK, RAMPS, COURTYARD AND LANDSCAPING, SEE LANDSCAPE DESIGN DRAWINGS FOR DETAILS
- REPLACE PAINTWORKS AS PER OHS REQUIREMENTS
- EXISTING DRIVEWAY ACCESS TO BE REMOVED
- EXISTING BUS STOP SIGN TO BE REMOVED AND RELOCATED
- NON MOUNTABLE CURBS AS PER AMCO STD. DWG. NO. C4 (TYP.) TO BE PAINTED RED IN BUS STOP AREA
- ASPHALT PAVING AS PER AMCO STD. DWG. NO. C3 (TYP.). SEE LAP JOINT DETAIL ON SHEET C301
- 8.0m WIDE CONCRETE DRIVEWAY AS PER OHS STD. DWG. NO. C735 AND C733 C/W BRUSHED CONCRETE SIDEWALK
- CONCRETE SIDEWALK AS PER OHS STD. DWG. NO. C735 AND C185. WIDTH TO MATCH EXISTING AND ON-SITE LANDSCAPING.
- BRICK PAVEMENT PATIO, SEE LANDSCAPE DESIGN DRAWINGS FOR DETAILS
- EXISTING UTILITY POLE TO BE RELOCATED, SEE BC HYDRO DESIGN DRAWINGS FOR DETAILS
- RIGHT W/RIGHT OUT SIGNAGE
- REPLACEMENT TREES AND GRATES, SEE LANDSCAPE DESIGN DRAWINGS FOR DETAILS. NO GRATE ON TRUCK 500 REPLACEMENT.
- REINSTATE EXISTING PATHWAYS, STAIRS AND GARDEN BEDS AS REQUIRED
- EXISTING MEMORIAL GARDEN AREA, AREA TO BE PROTECTED AND GREAT CARE GIVEN WHEN WORKING IN THIS AREA.

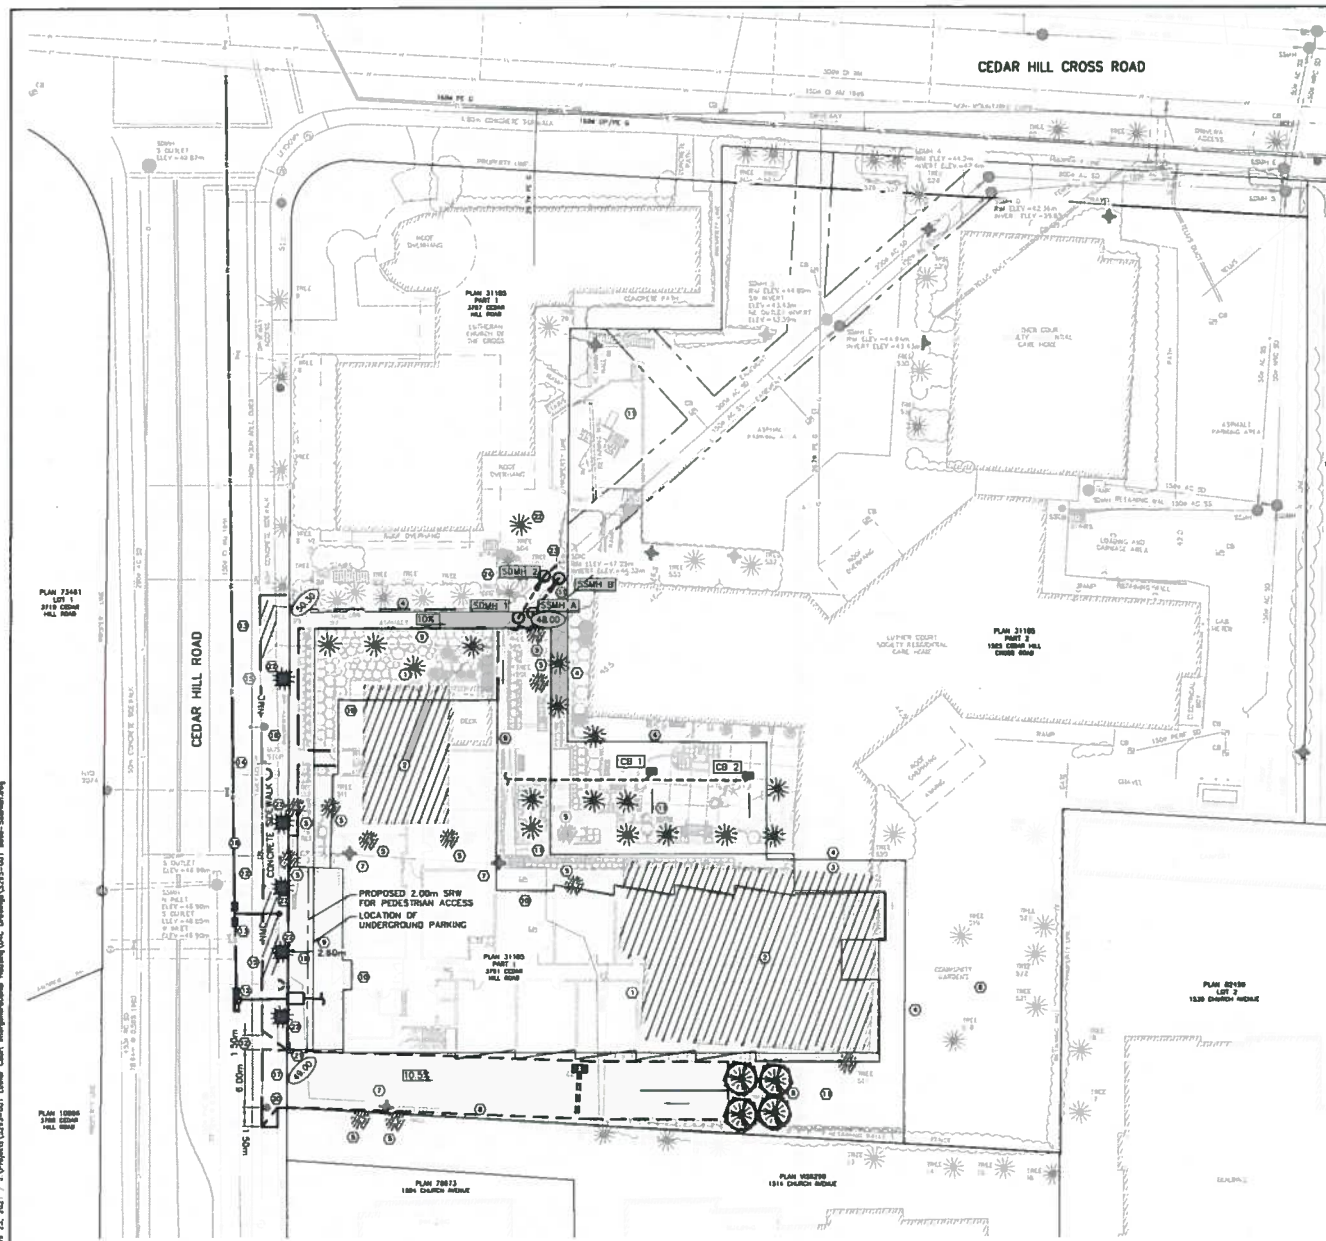

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 APRIL 26 2021

THE DISTRICT OF SAANICH, April 23, 2021 // A:\Projects\13295-001 Lufher Court, Interprovincial, Nanaimo\13295-001 Inter-Sanwich.dwg

CONFIRM UNDERGROUND LOCATIONS WITH UTILITY COMPANIES
 THE LOCATION AND ELEVATION OF THE EXISTING UNDERGROUND INFRASTRUCTURE SHOWN ON THIS DRAWING MAY NOT BE ACCURATE OR COMPLETE. THE ACTUAL HORIZONTAL AND VERTICAL LOCATIONS MUST BE CONFIRMED PRIOR TO THE START OF ANY CONSTRUCTION.

COMMENTS

STAMP

REVISIONS
1
2
3
4
5
6


APPROVED BY	SIGN	DATE



DISTRICT OF SAANICH
 LUTHER COURT - INTERPROVINCIAL HOUSING PROJECT
 SURFACE WORK AND GRADING PLAN

DESIGN: 5295-001
 CHECKED: AJV
 DATE: MAY 4 2021



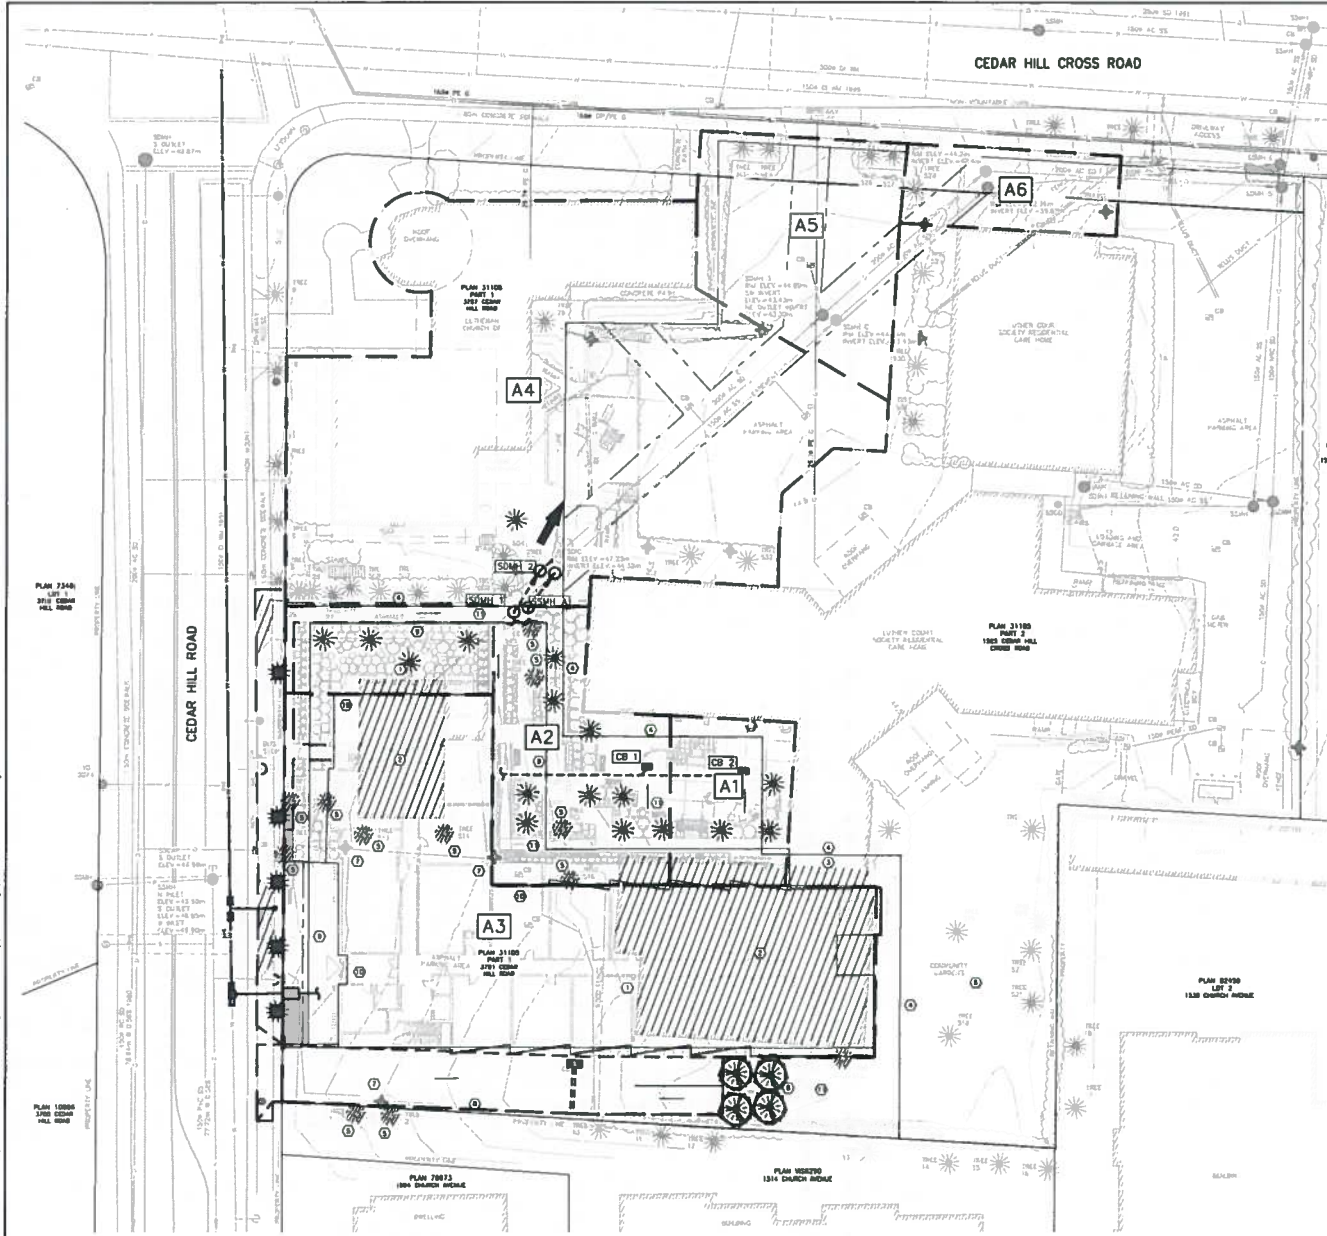

- NOTES:**
- FOR SITE DEMOLITION, SEE ARCHITECTURAL DESIGN DRAWINGS.
 - FOR GENERAL NOTES SEE SHEET CIVIL.

- DETAILED CONSTRUCTION NOTES:**
- PORTION OF EXISTING BUILDING TO BE REMOVED
 - SITE DEMOLITION, SEE ARCHITECTURAL DESIGN DRAWINGS FOR DETAILS
 - GRADING FLOOR AND BRIDGE CONNECTION TO EXISTING BUILDING, SEE ARCHITECTURAL DESIGN DRAWINGS FOR DETAILS
 - PROPOSED PARCEL BOUNDARY
 - EXISTING TREE TO BE REMOVED (TYP.)
 - EXISTING COMMUNITY GARDENS TO BE RETAINED
 - EXISTING LAMP STANDARDS TO BE REMOVED
 - WOOD FENCE AND LANDSCAPE AREAS, SEE LANDSCAPE DESIGN DRAWINGS FOR DETAILS
 - PARKING LEVEL OUTLINE
 - MAIN FLOOR BUILDING OUTLINE
 - ON-SITE SIDEWALK, RAMPS, COURTYARD AND LANDSCAPING, SEE LANDSCAPE DESIGN DRAWINGS FOR DETAILS

CATCHMENT	FROM	TO	AREA (ha)	I (mm/hr)	FLOW (L/s)	CU FLOW (L/s)	PIPE SIZE (mm)	LENGTH (m)	PIPE SLOPE	PIPE CAP (L/s)	MAX V (m/s)
A1	CB 2	CB 1	0.02	34.4	1.8	1.9	150	10.0	1.0%	18.0	1.0
A2	CB 1	BLDC	0.06	34.4	5.7	7.6	150	16.0	1.0%	18.0	1.0
A3	BLDG	SDMH 1	0.18	34.4	17.0	24.6	200	2.0	1.0%	38.8	1.2
	SDMH 1	SDMH 2				24.6	200	4.0	1.2%	43.3	1.4
A4	SDMH 2	SDMH 3	0.19	34.4	17.9	42.5	200	36.8	2.5%	60.8	2.0
A5	SDMH 3	SDMH 4	0.05	34.4	4.7	47.2	200	22.5	4.7%	83.7	2.7
A6	SDMH 4	SDMH 5	0.02	34.4	1.9	49.1	200	31.0	3.0%	87.1	2.1

REQUIRED STORAGE=24.0m³
 ALLOWABLE DISCHARGE=2.8 L/s
 SCHEDULE H, TYPE 2 WATERPROOF
 STORAGE 100m³/ha IMPERVIOUS AREA
 DISCHARGE=10L/s/HA
 STORAGE TO BE PROVIDED WITHIN BUILDING,
 DISCHARGE TO BE VIA PUMP TO SDMH 1

Tc: 5 min.
 R: 0.011
 IDF DATA:
 STATION
 10 YEAR RETURN PERIOD EVENT
 10% INCREASE TO RAINFALL INTENSITY
 TO ACCOUNT FOR CLIMATE CHANGE
 RUNOFF COEFFICIENT C=0.9

MAJOR FLOW ARROW



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 C:\Projects\2021\1525-001\1525-001-001-001.dwg

DEVELOPMENT PERMIT
 APRIL 26 2021

DISTRICT OF SAANICH RECEIVED
 LUTHER COURT - INTERNATIONAL WITNESS PROJECT
 STORM WATER MANAGEMENT PLAN
 E.M.: JON BOWEN | Date: 30.09.20
 Design: J.S. | Drawn: SAC | Checked: A.H. | Drawing No.: 6400
 Scale: 1:500 | Title: WMP | Date: 20.04.2021

MAY 04 2021
 PLANNING DEPT

CONFIRM UNDERGROUND LOCATIONS WITH UTILITY COMPANIES	COMMENTS	STAMP	REVISIONS	APPROVED BY	SIGN	DATE
			1			
			2			
			3			
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			5			
			6			

DATE: 2021-04-23 11:23:00
 PROJECT: 1525-001
 DRAWING: 1525-001-001-001
 TITLE: STORM WATER MANAGEMENT PLAN
 AUTHOR: JON BOWEN
 CHECKED: A.H.
 DATE: 2021-04-23